


Hobbs Building Systems, LLC 3311 100th Street, #3537 Urbandale, IA 50323 Phone: 515.473.9255 Fax: 515.974.4399 Email: info@hobbsbuildingsystems.com Website: www.hobbsverticalicf.com

Sheet List				
Sheet Number				
1	COVER SHEET			
2	PROJECT INFO			
3	LAYOUT PLAN			
4	LAYOUT PLAN			
5	WALL SECTIONS			
6	WALL SECTIONS			
7	DETAILS			
8	DETAILS			
9	DETAILS			
10	DETAILS			

### PATENTS:

U.S.: #8,371,082 CANADA: #2,621,024

# SHOP DRAWINGS FOR: Project Example 3 Marana, AZ

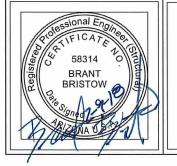

I HEREBY CERTIFY THAT THIS ENGINEERING DOCUMENT WAS PREPARED BY ME OR UNDER MY DIRECT PERSONAL SUPERVISION AND THAT I AM A DULY REGISTERED PROFESSIONAL ENGINEER UNDER THE LAWS OF THE STATE OF ARIZONA THIS NOTICE COVERS HORBS FOUNDATIONS ONLY, SEE NOTE BELOW SIGNATURE:

NAME: DATE: 09 FEB 2018

BRANT BRISTOW, P.E. 58314

MY REGISTRATION EXPIRES ON 30-SEPTEMBER-2020

THIS STAMP COVERS THE FOUNDATION & CONCRETE WALLS POURED WITH THE HOBBS FOUNDATION SYSTEM ONLY. NO OTHER PORTIONS OF THE PROJECT ARE REPRESENTED INCLUDING BUT NOT LIMITED TO FOOTINGS, FLOORS, WOOD FRAMED WALLS OR ROOF FRAMING

All drawings and details shall be constructed in accordance with the local building code regulations, project engineering, and construction practices. Design contained herein are protected by copyright, recipient acknowledges contents are property of Hobbs Building Systems, LLC., and shall be used only for construction purposes and not copied, used or reproduced, for any other purposes or projects without written permission from Hobbs Building Systems, LLC. all rights

reserved. Hobbs Building Systems, LLC. 2015. Hobbs Building Systems, LLC reserves the right to

make changes to the drawings/information shown without notice.

HOBBS

Vertical ICF Wall System

Go Engineered. Go Easy. Go Green.

JOB # 172093

NOT FOR CONSTRUCTION

FOR CONSTRUCTION

ISSUE DATE :

121417 REVISIONS:

 $\begin{array}{c|cccc}
\hline
1 & - & & 6 \\
\hline
2 & & & 7 \\
\hline
3 & & & 8 \\
\hline
4 & & & 9
\end{array}$ 

DRAWING SCALE:

**DRAWING NAME:** 

**COVER SHEET** 

LINTEL SCHEDULE					
MARK	LINTEL BAR	SHEAR REINFORCING	HEAD R.O.	LINTIL DEPTH	WIDTH R.O.
L1	#5 (R.O. + 1'-0")	#3 STIRRUP W/ 2 1/2" HOOK EA. END @ 12" O.C.	VERIFY	1'-7" MIN.	2'-0"
L2	#5 (R.O. + 1'-0")	#3 STIRRUP W/ 2 1/2" HOOK EA. END @ 12" O.C.	VERIFY	1'-7" MIN.	3'-0"
L3	#5 (R.O. + 1'-0")	#3 STIRRUP W/ 2 1/2" HOOK EA. END @ 12" O.C.	VERIFY	1'-7" MIN.	4'-0"
L4	#5 (R.O. + 1'-0")	#3 STIRRUP W/ 2 1/2" HOOK EA. END @ 12" O.C.	VERIFY	1'-7" MIN.	5'-0"
L5	#5 (R.O. + 1'-0")	#3 STIRRUP W/ 2 1/2" HOOK EA. END @ 12" O.C.	VERIFY	1'-8" MIN.	6'-0"
L6	2- #5 (R.O. + 1'-0")	#3 STIRRUP W/ 2 1/2" HOOK EA. END @ 12" O.C.	VERIFY	2'-0" MIN.	18'-0"

DOWEL NOTES:

### BASEMENT WALL REINFORCING SCHEDULE

LOCATION	WALL HT.	VERT. REINF. BAR	SPACING	POSITION
*@ BUTTRESS & STAIR	6'-0"	#5	16" O.C.	CENTER
@ BASEMENT	10'-1 1/2"	#5	16" O.C.	OFFSET

\* BUTTRESS & STAIR WALL TO HAVE #5 HORIZONTAL BARS @ 18" O.C.

### MAIN FLOOR WALL REINFORCING SCHEDULE

LOCATION	VALALL LIT	VEDT DEINE DAD	ODAGINO	POSITION
LOCATION	WALL HT.	VERT. REINF. BAR	SPACING	POSITION
@ MAIN FLOOR	9'-0"	#4	16" O.C.	CENTER
@ GARAGE	9'-0"	#4	16" O.C.	CENTER

### DOWEL REINFORCING SCHEDULE

ALL DOWELS TO START 12" IN FROM OUTSIDE OF FORM CORNER

DOWELS NOT TO EXCEED SPECIFIED SPACING PER SCHEDULE

DOWEL SPACINGS NOT REQUIRED TO ALIGN WITH VERT. BARS

LOCATION	VERT. REINF. BAR	SPACING	EMBED	PROJECTION	POSITION
@ FOOTING	#4	32" O.C.	6"	6"	CENTER
@ TOP OF WALL	#4	32" O.C.	6"	6"	CENTER

## **ABBREVIATIONS**

BEAM		
BEAW		

BTM. = **BOTTOM** 

CONT. = CONTINUOUS CTR. CENTER

DWL. **DOWEL** FA. **EACH** ELEV. = **ELEVATION** E.O. **EVERY OTHER** 

E.S. **EXPOSED STUD** FLR. **FLOOR** FTG. **FOOTING** 

G-V **GABLE - VARIES** HORIZ. = **HORIZONTAL** MIN. MINIMUM

O.C. ON CENTER PL. PLATE

LBS PER SQUARE FOOT **PSF** REINF. = REINFORCING

R.O. **ROUGH OPENING** STUCCO READY S.R. T.O.W. = TOP OF WALL TYP. = **TYPICAL** 

VERT. = **VERTICAL** 

VICF VERTICAL INSULATED CONCRETE FORM =

WITH = W.H. WALL HEIGHT

# GENERAL NOTES / DESIGN DATA

### **DESIGN PARAMETERS:**

1. BUILDING CODE REFERENCE INTERNATIONAL RESIDENTIAL CODE 2012 2011 EDITION ACI 318

### 2. LOADS

2.1. DEAD LOADS ROOF: 20 PSF ICF WALLS: 75 PSF FLOORS: 25 PSF WOOD STUD WALLS: 15 PSF DECK: 15 PSF

2.2. LIVE LOADS ROOF: 20 PSF (SNOW) FLOORS: 40 PSF

MAXIMUM NET WIND PRESSURE: +/- 19.5 PSF (SERVICE) V = 90 MPH, EXP. C, I = 1.0

2.4 LATERAL EARTH PRESSURE ON FOUNDATION WALLS:30 PSF/FT

### **CONSTRUCTION MATERIAL:**

### 1. CONCRETE:

MINIMUM COMPRESSIVE DESIGN STRENGTH AT 28 DAYS OF 3,000 PSI, MAXIMUM WATER-TO-CEMENT RATIO, W / CM = 0.43. 3/8" LIMESTONE CHIPS OR 3/8" WASHED RIVER ROCK AGGREGATE, 4" TO 5" SLUMP. CAN SUBSTITUTE 15% CLASS C FLYASH BY WEIGHT FOR CEMENT IN CONCRETE MIX

### 2. REINFORCEMENT:

ASTM A615 GRADE 60.

### **GENERAL NOTES:**

GENERAL CONTRACTOR SHALL BE RESPONSIBLE FOR COORDINATION OF DETAILS PROVIDED FOR HOBBS WALL SYSTEM WITH FOUNDATIONS, FLOOR & ROOF FRAMING. THIS DRAWING SET IS NOT MEANT TO BE DEFINITIVE FOR BUILDING DIMENSIONS & LAYOUT. ICF WALL INSTALLATION SHOULD BE COORDINATED WITH OTHER TRADES & BUILDING DIMENSIONS & LAYOUT CONFIRMED WITH THE APPROPRIATE PARTIES.

EARTH BACKFILL AGAINST BASEMENT WALLS SHALL BE GW, GP, SW, OR SP AND SHALL BE TILED AT FOOTING ELEVATION.



Go Engineered. Go Easy. Go Green



☐ NOT FOR CONSTRUCTION



ISSUE DATE:

121417

**REVISIONS:** 


1 -	6
2	7
3	8
4	9
5	/10\

DRAWING SCALE:

12" = 1'-0"

DRAWING NAME:

PROJECT INFO

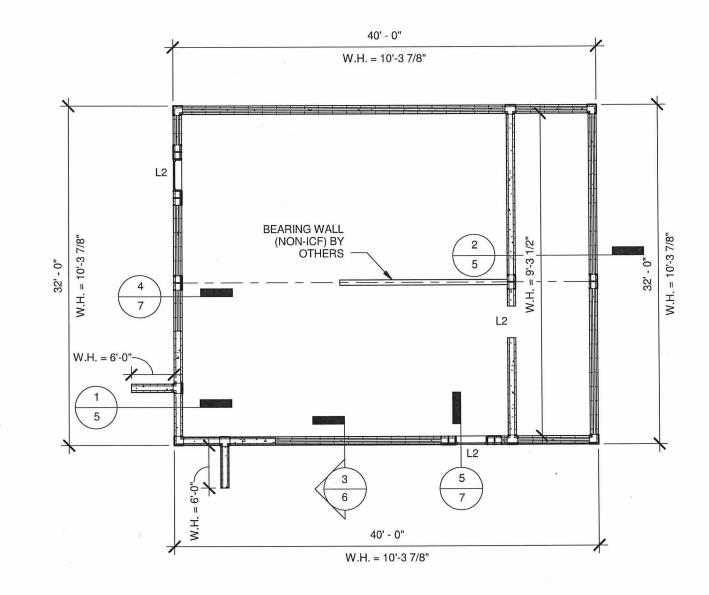

# WALL TYPES

CONTOUR WALL - EXPOSED STUD

FLAT WALL - EXPOSED STUD

### NOTES:

- BUILDING DIMENSIONS FOR REFERENCE ONLY SEE
   ARCHITECTURAL PLANS FOR ALL DIMENSIONS ARCHITECTURAL PLANS TO TAKE PRESEDENCE
- 2. PROVIDE FOOTING DRAINAGE PER DETAIL 1 / 6
  DRAIN TILE TO BE PROVIDED BY OTHERS TO BE
  INSTALLED PER CODE.



Go Engineered. Go Easy. Go Green.



JOB #: 172093

☐ NOT FOR CONSTRUCTION

FOR CONSTRUCTION

ISSUE DATE:

121417

**REVISIONS:** 

<u>1</u> - <u>/</u> <u>2</u> <u>/</u> <u>3</u> <u>/</u> <u>/</u>

5

DRAWING SCALE:

1/8" = 1'-0"


DRAWING NAME:

LAYOUT PLAN

# **WALL TYPES**

CONTOUR WALL - EXPOSED STUD

FLAT WALL - EXPOSED STUD

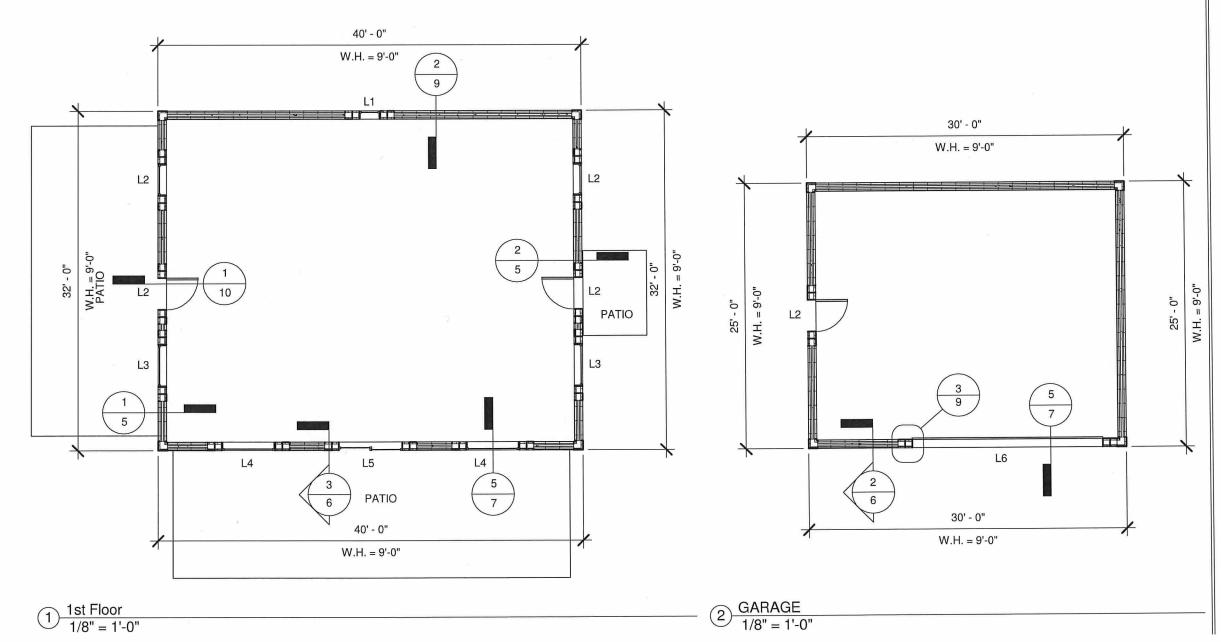

HOBBS

Vertical ICF Wall System

Go Engineered. Go Easy. Go Green.



JOB #: 17209


☐ NOT FOR CONSTRUCTION

FOR CONSTRUCTION

ISSUE DATE:

121417

REVISIONS:

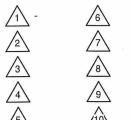



DRAWING SCALE:

1/8" = 1'-0"

DRAWING NAME:

LAYOUT PLAN

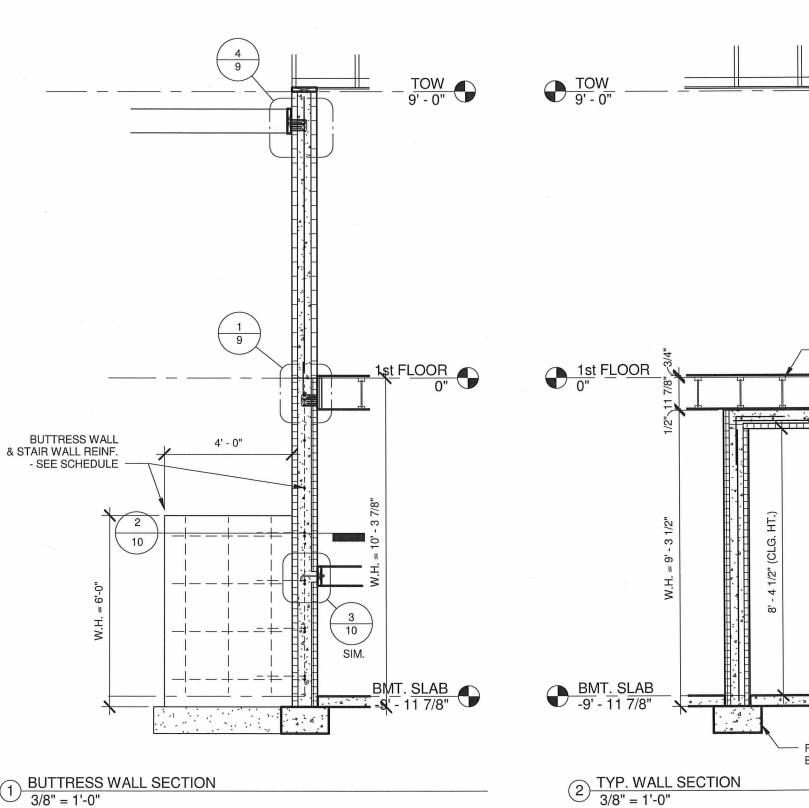

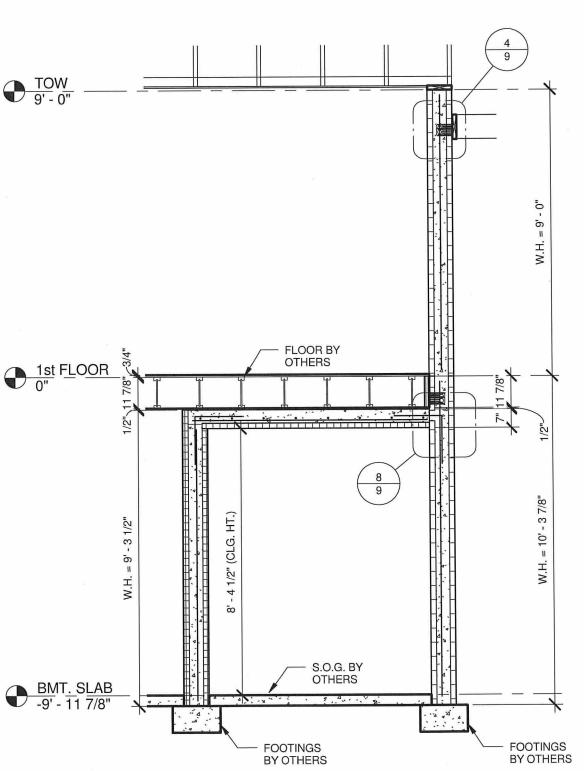





JOB#: 17209

NOT FOR CONSTRUCTION

FOR CONSTRUCTION

ISSUE DATE:

121417


**REVISIONS:** 

DRAWING SCALE:


3/8" = 1'-0"

DRAWING NAME:

WALL SECTIONS

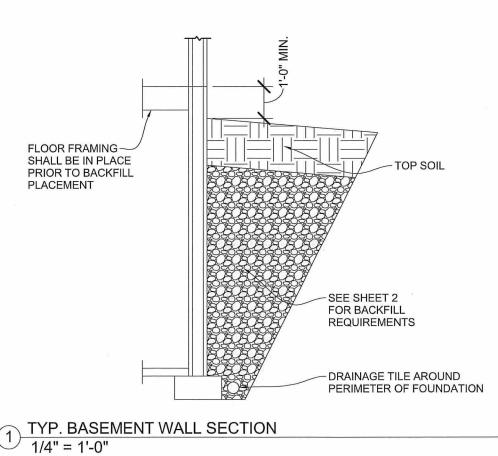

W.H. = 9' - 0" S.O.G. & FTG. BY OTHERS **GARAGE WALL SECTION** 1/4" = 1'-0"

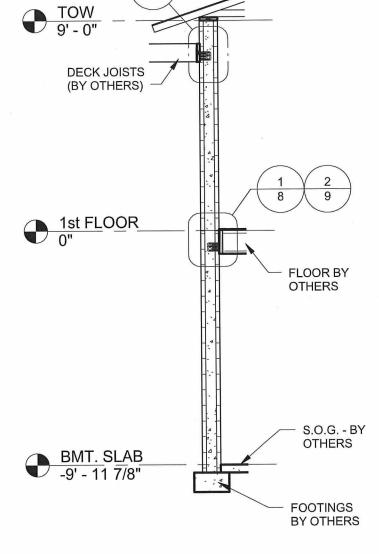

WALL SECTION 1/4" = 1'-0"

**HOBBS** Vertical ICF Wall System

Go Engineered. Go Easy. Go Green.



■ NOT FOR CONSTRUCTION

FOR CONSTRUCTION

ISSUE DATE:

121417


**REVISIONS:** 


DRAWING SCALE:

1/4" = 1'-0"

DRAWING NAME:

WALL SECTIONS

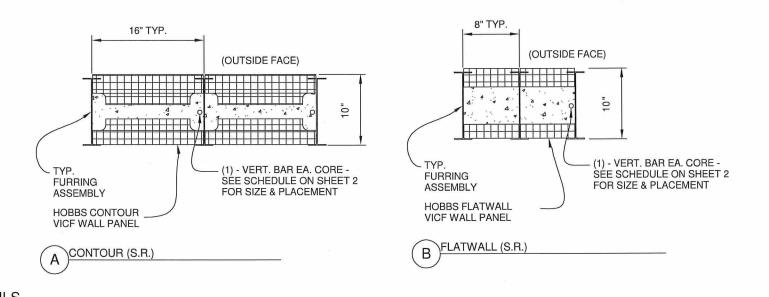

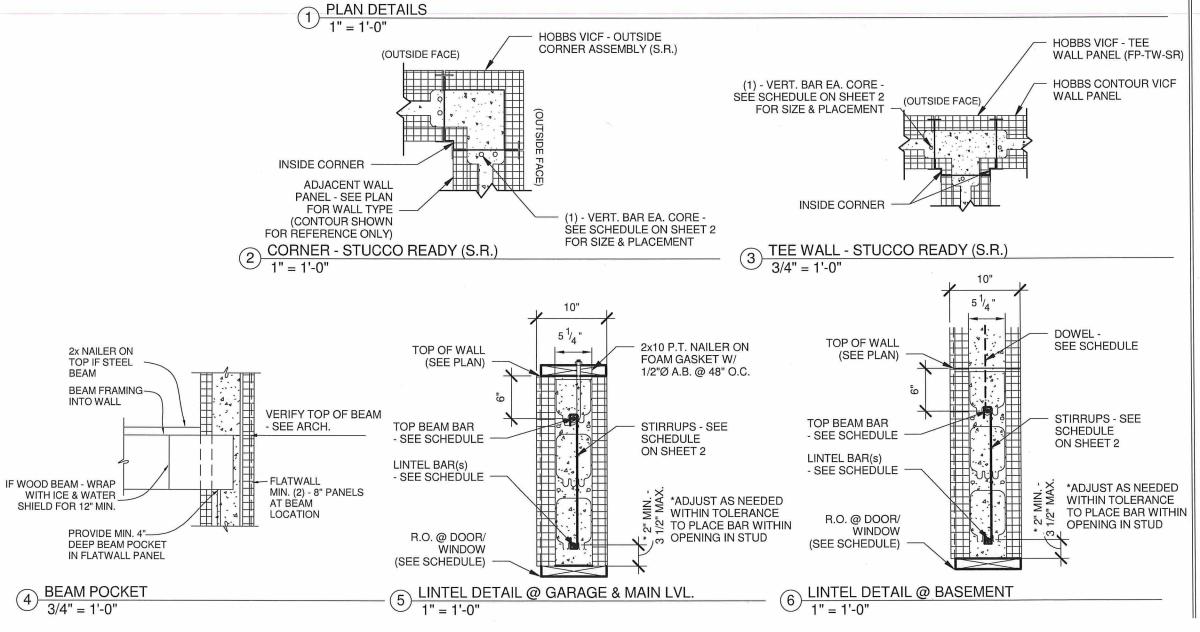



Go Engineered. Go Easy. Go Green.



NOT FOR CONSTRUCTION

FOR CONSTRUCTION

ISSUE DATE:

121417

REVISIONS:

1 - 6
2 /7
3 8
4 /9
5 /10


7

DRAWING SCALE:


As indicated


DRAWING NAME:

**DETAILS** 

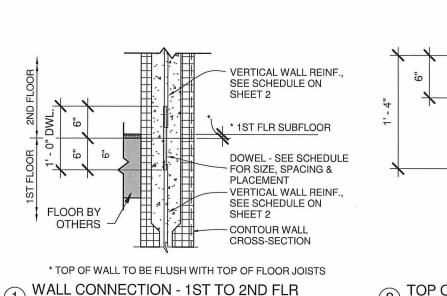

3/4" = 1'-0"

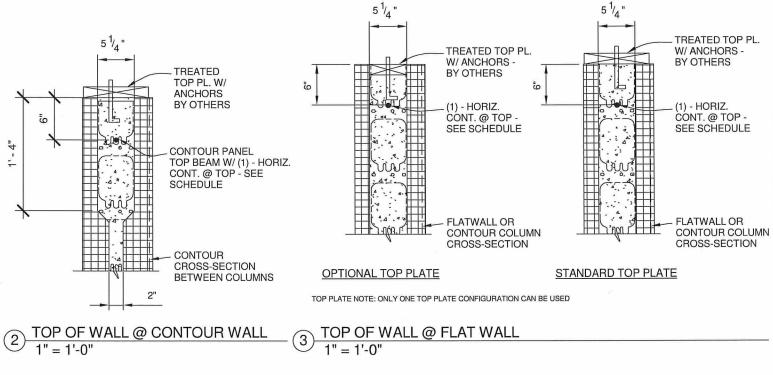

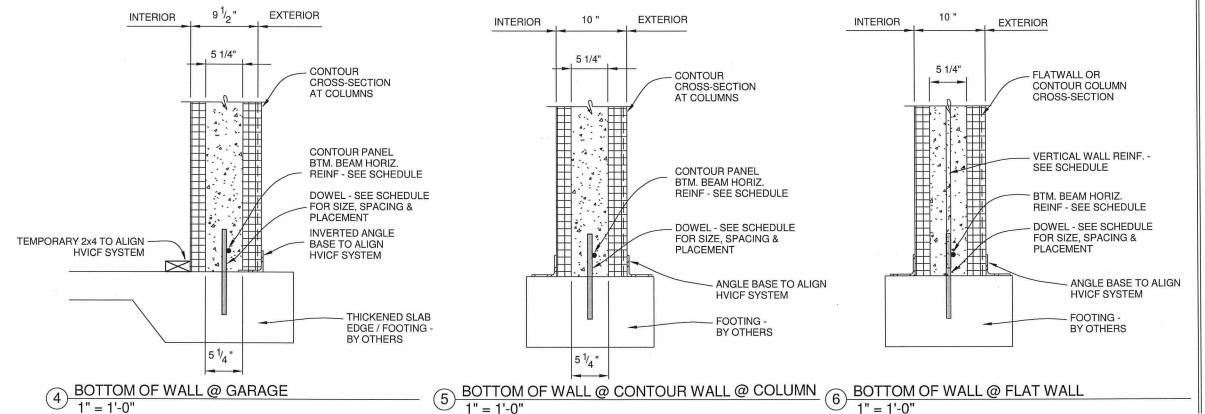



Go Engineered. Go Easy. Go Green.



JOB #: 17209;

NOT FOR CONSTRUCTION

FOR CONSTRUCTION

ISSUE DATE:

121417

REVISIONS:

7


<u>/</u>3\ <u>/</u>4

DRAWING SCALE:

As indicated

DRAWING NAME:

**DETAILS** 

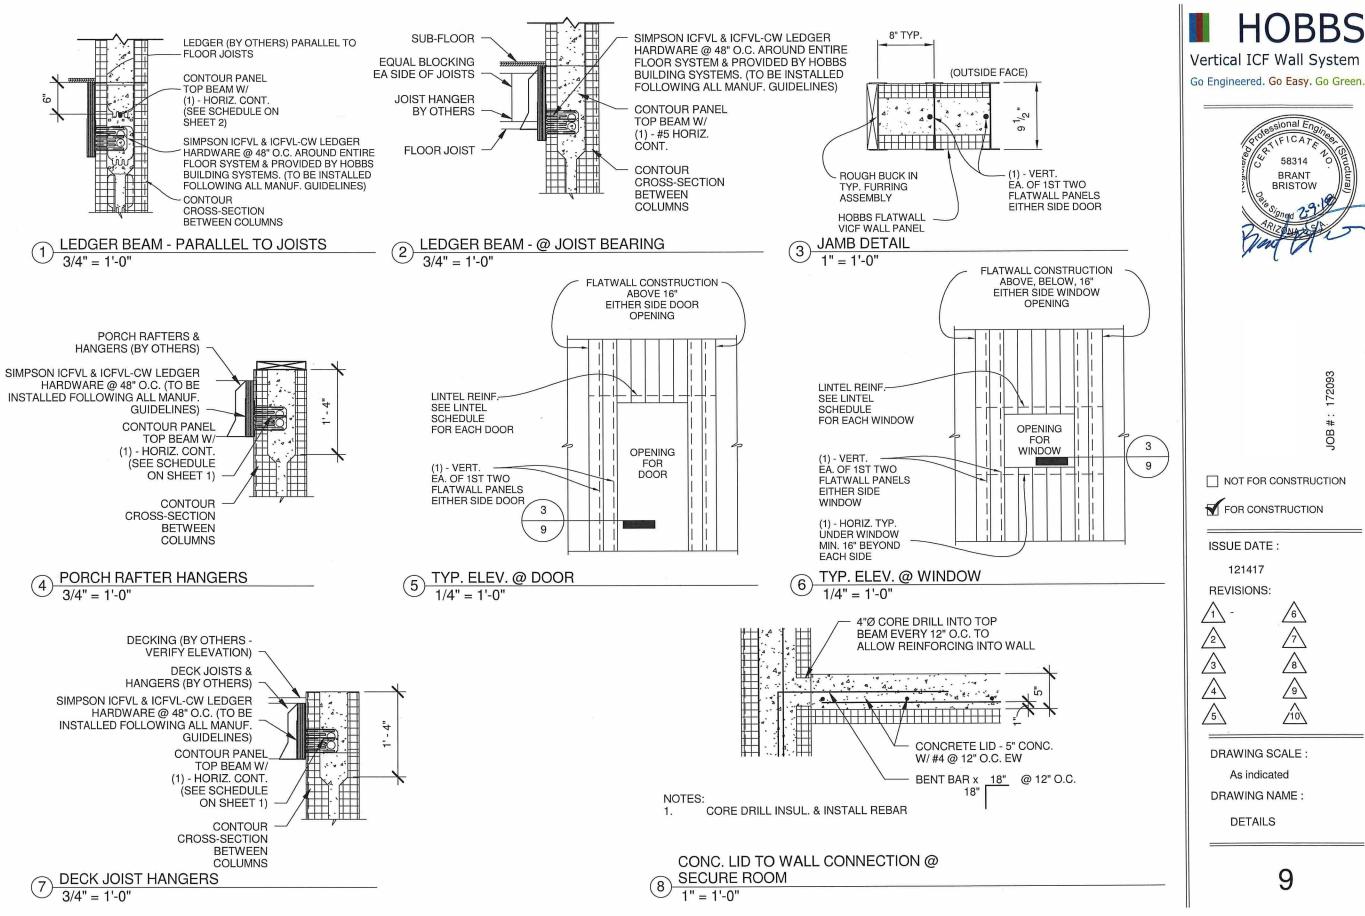

**HOBBS** 

Vertical ICF Wall System



JOB

☐ NOT FOR CONSTRUCTION

FOR CONSTRUCTION

ISSUE DATE:

121417


**REVISIONS:** 

DRAWING SCALE:

As indicated

DRAWING NAME:


**DETAILS** 

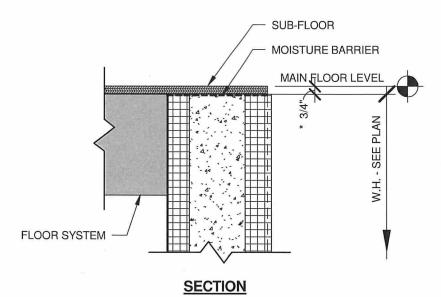


### NOTES

- TOP OF HVICF WALL = TOP OF FLOOR JOISTS
- INSTALL MOISTURE BARRIER BETWEEN SUB-FLOOR AND TOP OF WALL
- FLOOR JOISTS TO BEAR ON LEDGER OR
  - EMBEDED JOIST HANGER
  - \*CONTRACTOR IS RESPONSIBLE FOR DETERMINING FINISH FLOOR ELEVATION

1 DOOR SILL DETAIL
1 1/2" = 1'-0"

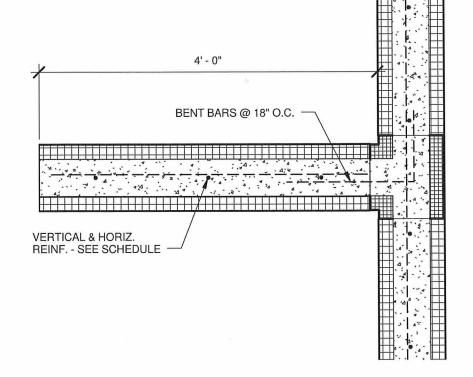

2 BUTTRESS WALL PLAN SECTION
1" = 1'-0"

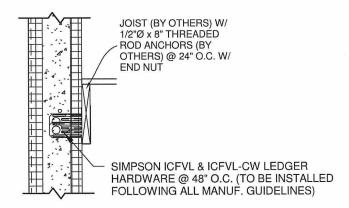

3 LANDING LEDGER
3/4" = 1'-0"



Vertical ICF Wall System

Go Engineered. Go Easy. Go Green.



JOB #: 1720

■ NOT FOR CONSTRUCTION



ISSUE DATE:

121417

**REVISIONS:** 

<u>/</u>

DRAWING SCALE:

As indicated

DRAWING NAME:

**DETAILS**