

Project Example 1 Sedalia, CO.

Hobbs Building Systems, LLC 3311 100th Street, #3537 Urbandale, IA 50323 Phone: 515.473.9255

Fax: 515.974.4399

Email: info@hobbsbuildingsystems.com Website: www.hobbsverticalicf.com

	Sheet List	
Sheet	Chast Navas	
Number	Sheet Name	

1	COVER SHEET	
2	PROJECT INFO	
3	LAYOUT PLAN	
4	LAYOUT PLAN	
5	WALL SECTIONS	
6	WALL SECTIONS	
7	DETAILS	
8	DETAILS	
9	DETAILS	

JAMES E. TOMETICH 39511

I HEREBY CERTIFY THAT THIS ENGINEERING DOCUMENT WAS PREPARED BY ME OR UNDER MY DIRECT PERSONAL SUPERVISION AND THAT I AM A DULY REGISTERED PROFESSIONAL ENGINEER UNDER THE LAWS OF THE STATE OF COLORADO. THIS NOTICE COVERS HOBBS FOUNDATIONS ONLY, SEE NOTE BELOW SIGNATURE:

NAME: DATE:

SHOP DRAWINGS FOR:

21-JUL 2018 E. TOMETICH, P.E.

MY REGISTRATION EXPIRES ON 31-OCTOBER-2019

THIS STAMP COVERS THE FOUNDATION & CONCRETE WALLS POURED WITH THE HOBBS FOUNDATIONS SYSTEM ONLY. NO OTHER PORTIONS OF THE PROJECT ARE REPRESENTED INCLUDING BUT NOT LIMITED TO FOOTINGS, FLOORS, WOOD FRAMED WALLS OR ROOF FRAMING

PATENTS:

U.S.:

#8.371.082 CANADA: #2,621,024

All drawings and details shall be constructed in accordance with the local building code regulations, project engineering, and construction practices. Design contained herein are protected by copyright, recipient acknowledges contents are property of Hobbs Building Systems, LLC., and shall be used only for construction purposes and not copied, used or reproduced, for any other purposes or projects without written permission from Hobbs Building Systems, LLC. all rights reserved. Hobbs Building Systems, LLC. 2015. Hobbs Building Systems, LLC reserves the right to make changes to the drawings/information shown without notice.



NOT FOR CONSTRUCTION FOR CONSTRUCTION ISSUE DATE: 020818 **REVISIONS:** 1 062018 DRAWING SCALE:

DRAWING NAME:

COVER SHEET

		LINTEL SCHEDULE			
MARK	LINTEL BAR	SHEAR REINFORCING	HEAD R.O.	LINTIL DEPTH	WIDTH R.O.
L1	#5 (R.O. = 1'-0")	#3 STIRRUP W/ 2 1/2" HOOK EA. END @ 6" O.C.	VERIFY	1'-7" MIN.	3'-0"
L2	#5 (R.O. = 1'-0")	#3 STIRRUP W/ 2 1/2" HOOK EA. END @ 6" O.C.	VERIFY	1'-7" MIN.	4'-0"
L3	#5 (R.O. = 1'-0")	#3 STIRRUP W/ 2 1/2" HOOK EA. END @ 6" O.C.	VERIFY	1'-7" MIN.	5'-0"
L4	2- #5 (R.O. = 1'-0")	#4 STIRRUP W/ 2 1/2" HOOK EA. END @ 6" O.C.	VERIFY	2'-0" MIN.	9'-0"
L5	2- #5 (R.O. = 1'-0")	#4 STIRRUP W/ 2 1/2" HOOK EA. END @ 6" O.C.	VERIFY	1'-8" MIN.	18'-0"

BASEMENT WALL REINFORCING SCHEDULE

LOCATION	WALL HT.	VERT. REINF. BAR	SPACING	POSITION
@ BUTTRESS	6'-0"	#5	16" O.C.	CENTER
@ BASEMENT	10'-4"	#5	16" O.C.	OFFSET
@ WALK-OUT	12'-8"	#5	16" O.C.	CENTER

MAIN FLOOR WALL REINFORCING SCHEDULE

	WALL HT.	VERT. REINF. BAR	SPACING	POSITION
@ MAIN FLOOR	9'-0"	#4	16" O.C.	CENTER
@ GARAGE & EXERCISE	12'-6"	#4	16" O.C.	CENTER

ABBREVIATIONS

BTM. = воттом CONT. = CONTINUOUS CTR. = CENTER DWL. = DOWEL **EACH** FA =ELEV. = **ELEVATION EVERY OTHER** E.O. **EXPOSED STUD** FLR. = FLOOR FTG. **FOOTING** GABLE - VARIES G-V HORIZ. = HORIZONTAL MINIMUM MIN. = O.C. ON CENTER PLATE PL.

PSF = LBS PER SQUARE FOOT
REINF. = REINFORCING
R.O. = ROUGH OPENING
S.R. = STUCCO READY
T.O.W. = TOP OF WALL
TYP. = TYPICAL

VERT. = VERTICAL VICF = VERTICAL INSULATED CONCRETE FORM

W/ = WITH

W.H. = WALL HEIGHT

GENERAL NOTES / DESIGN DATA

DESIGN PARAMETERS:

BUILDING CODE REFERENCE
 INTERNATIONAL RESIDENTIAL CODE 2012 WITH AMMENDMENTS
 FOR DOUGLAS COUNTY, COLORADO.
 2011 EDITION ACI 318

2. LOADS

2.1. DEAD LOADS ROOF: 20 PSF ICF WALLS: 75 PSF FLOORS: 20 PSF WOOD STUD WALLS: 15 PSF

2.2. LIVE LOADS ROOF: 50 PSF (SNOW) FLOORS: 40 PSF

2.3. WIND
MAXIMUM NET WIND PRESSURE: +/- 25.2 PSF (SERVICE)
V = 100 MPH, EXP. C, I = 1.0

2.4 LATERAL EARTH PRESSURE ON FOUNDATION WALLS:45 PSF/FT

CONSTRUCTION MATERIAL:

1. CONCRETE:

MINIMUM COMPRESSIVE DESIGN STRENGTH AT 28 DAYS OF 3,000 PSI, MAXIMUM WATER-TO-CEMENT RATIO, W / CM = 0.43. 3/8" LIMESTONE CHIPS OR 3/8" WASHED RIVER ROCK AGGREGATE, 4" TO 5" SLUMP. CAN SUBSTITUTE 15% CLASS C FLYASH BY WEIGHT FOR CEMENT IN CONCRETE MIX

2. REINFORCEMENT:

ASTM A615 GRADE 60.

GENERAL NOTES:

GENERAL CONTRACTOR SHALL BE RESPONSIBLE FOR COORDINATION OF DETAILS PROVIDED FOR HOBBS WALL SYSTEM WITH FOUNDATIONS, FLOOR & ROOF FRAMING. THIS DRAWING SET IS NOT MEANT TO BE DEFINITIVE FOR BUILDING DIMENSIONS & LAYOUT. ICF WALL INSTALLATION SHOULD BE COORDINATED WITH OTHER TRADES & BUILDING DIMENSIONS & LAYOUT CONFIRMED WITH THE APPROPRIATE PARTIES.

EARTH BACKFILL AGAINST BASEMENT WALLS SHALL BE GW, GP, GM, SW. OR SP AND SHALL BE TILED AT FOOTING ELEVATION.





DB # · 2020

NOT FOR CONSTRUCTION

FOR CONSTRUCTION



ISSUE DATE:

020818

REVISIONS:


062018


DRAWING SCALE:

12" = 1'-0"

DRAWING NAME:

PROJECT INFO

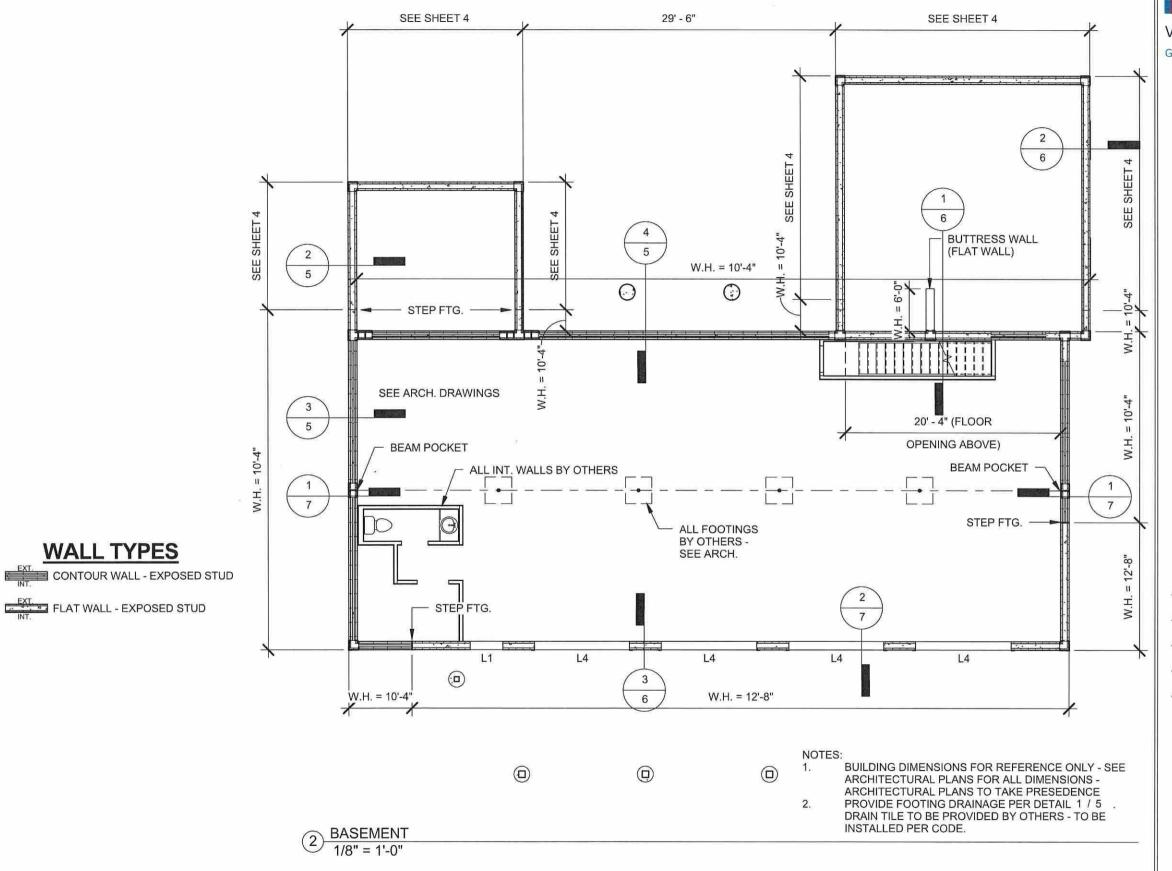


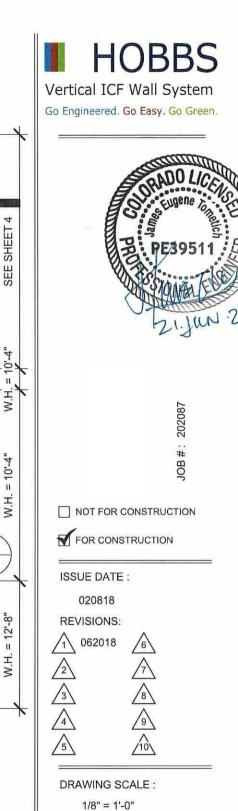

3

DRAWING NAME:

LAYOUT PLAN

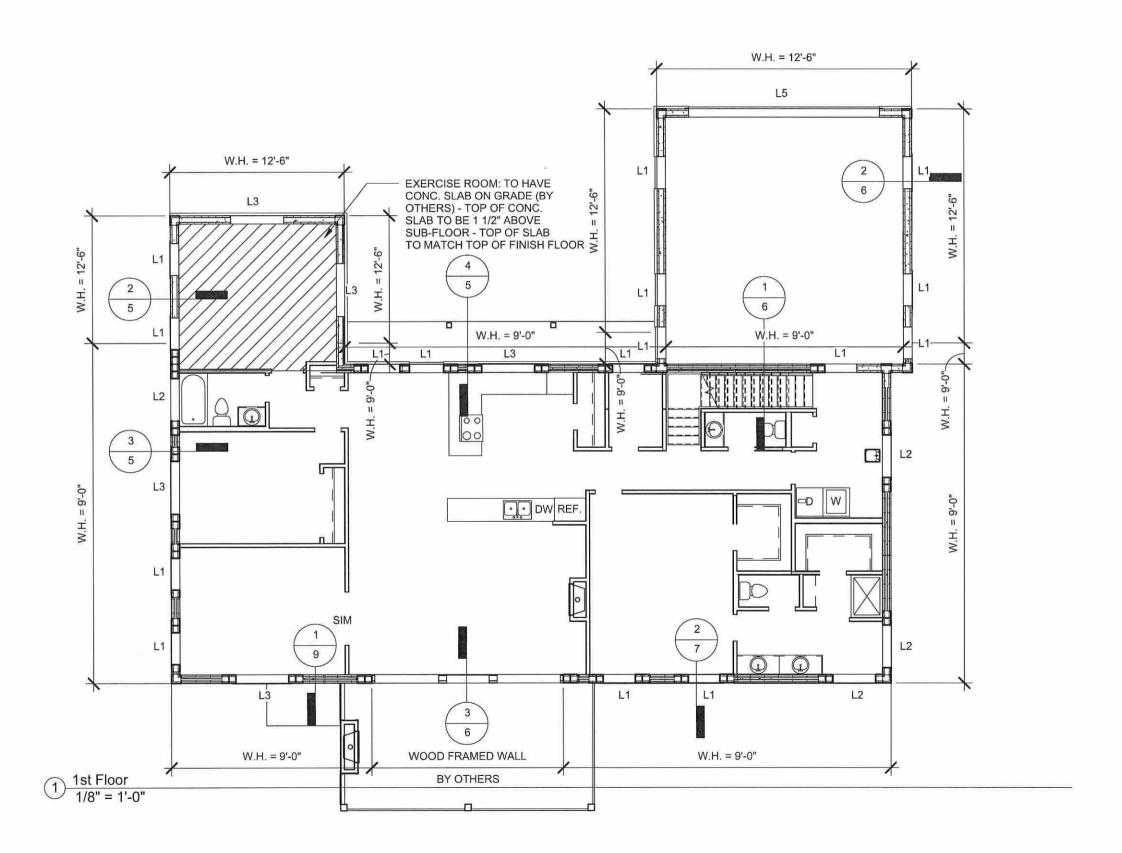




DRAWING SCALE:


1/8" = 1'-0"

DRAWING NAME:

LAYOUT PLAN

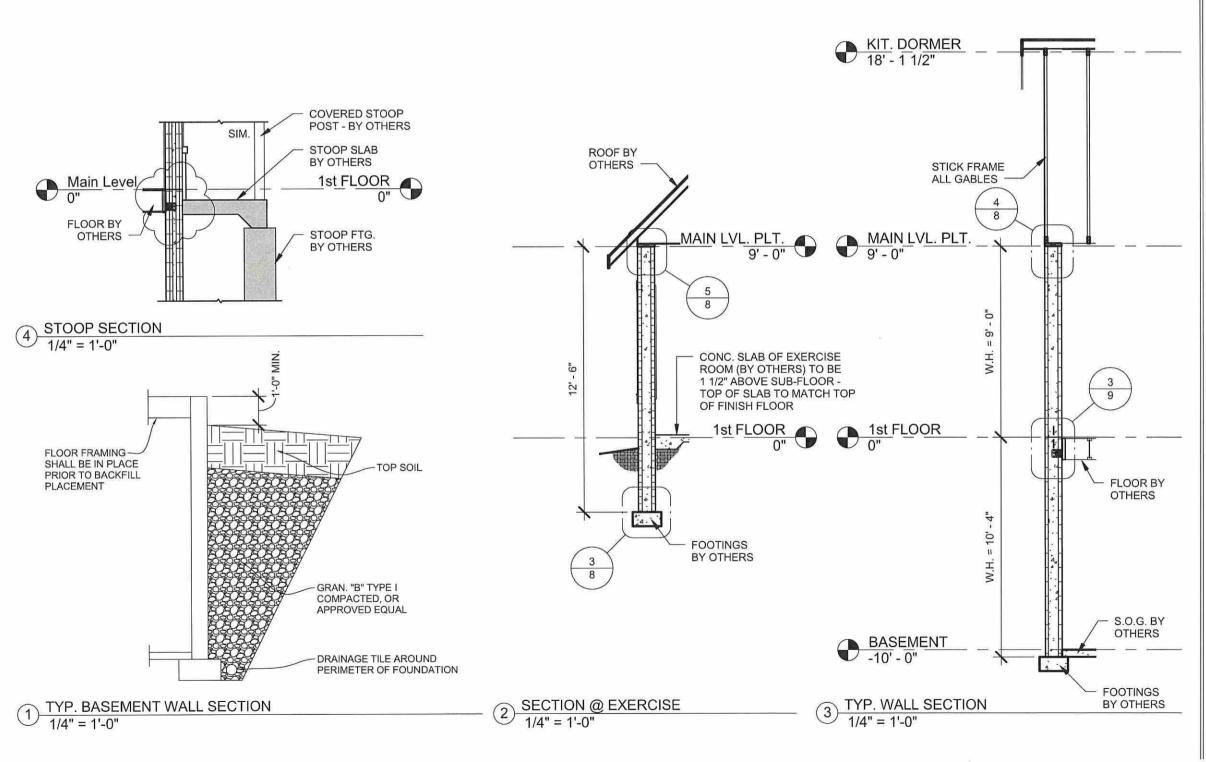



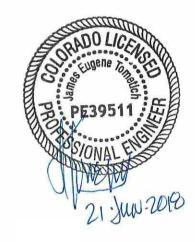

OR # · 20208

OR CONSTRUCTION

	/
\checkmark	FOR CONSTRUCTION

ISSUE DATE:

020818

REVISIONS:

1 062018 6 7 7 8


4 /9 /10\

DRAWING SCALE:


1/4" = 1'-0"

DRAWING NAME:

WALL SECTIONS

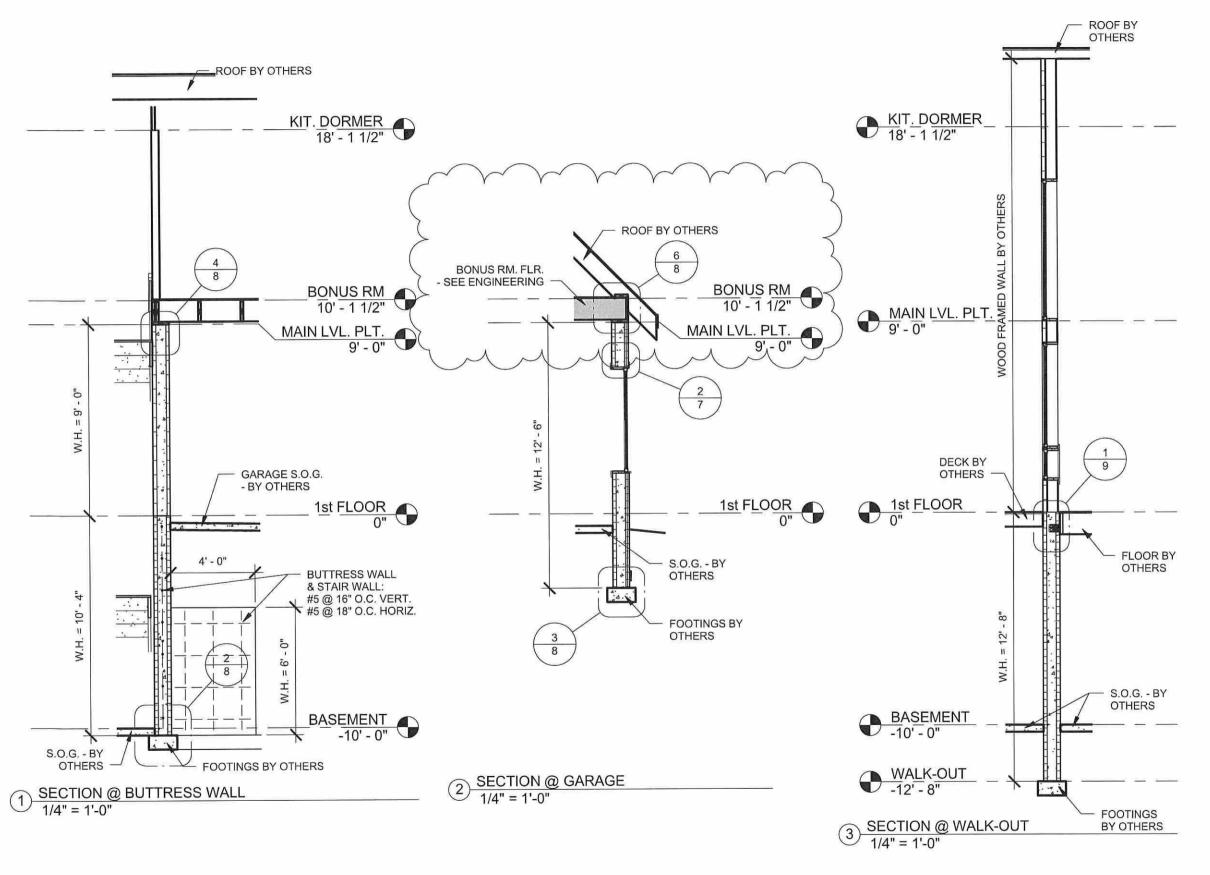



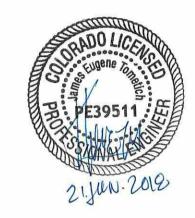

JOB #: 202

☐ NOT FOR CONSTRUCTION

FOR CONSTRUCTION

ISSUE DATE :

IOOOL DA

020818

REVISIONS:


1 062018 6 7 7 8 8 9 9

DRAWING SCALE:


1/4" = 1'-0"

DRAWING NAME:

WALL SECTIONS

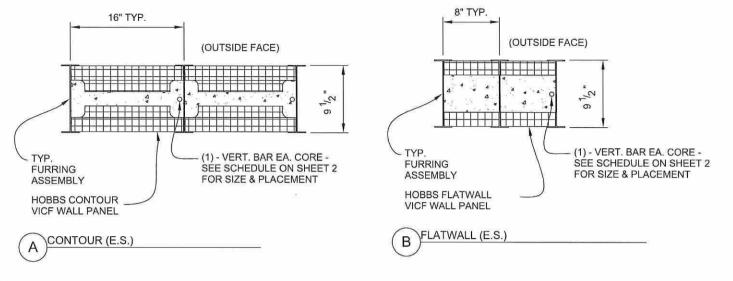

5 PLAN DETAILS 1" = 1'-0"

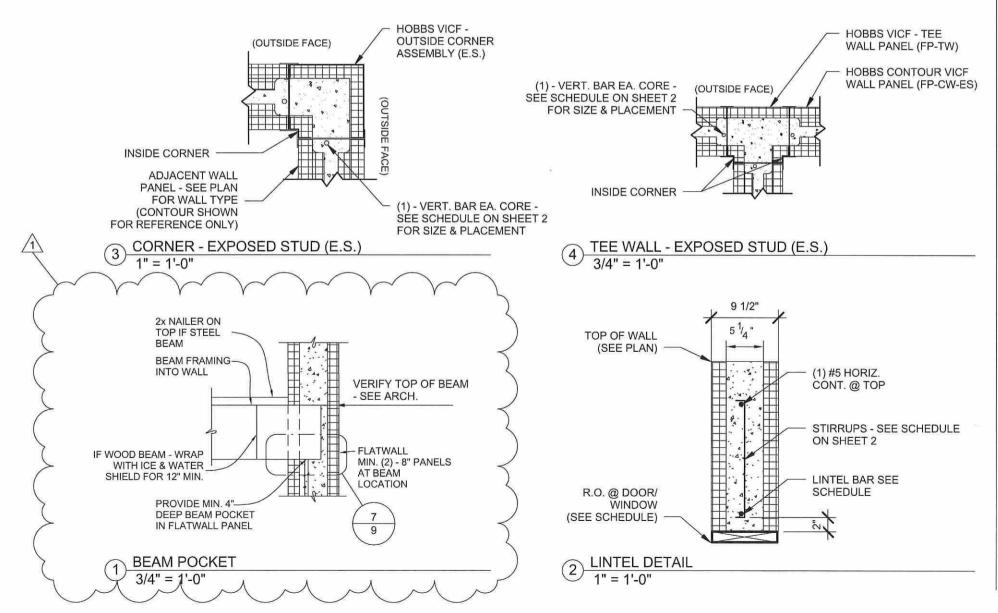





.IOR # · 202

■ NOT FOR CONSTRUCTION
FOR CONSTRUCTION

ISSUE DATE : 020818


REVISIONS:


 $\begin{array}{c|cccc}
 & & & & & & & & & & & \\
\hline
 & & & & & & & & & & \\
\hline
 & & & & & & & & & \\
\hline
 & & & & & & & & \\
\hline
 & & & & & & & & \\
\hline
 & & & & & & & & \\
\hline
 & & & & & & & \\
\hline
 & & & & & & & \\
\hline
 &$


DRAWING SCALE:

As indicated DRAWING NAME :

DETAILS

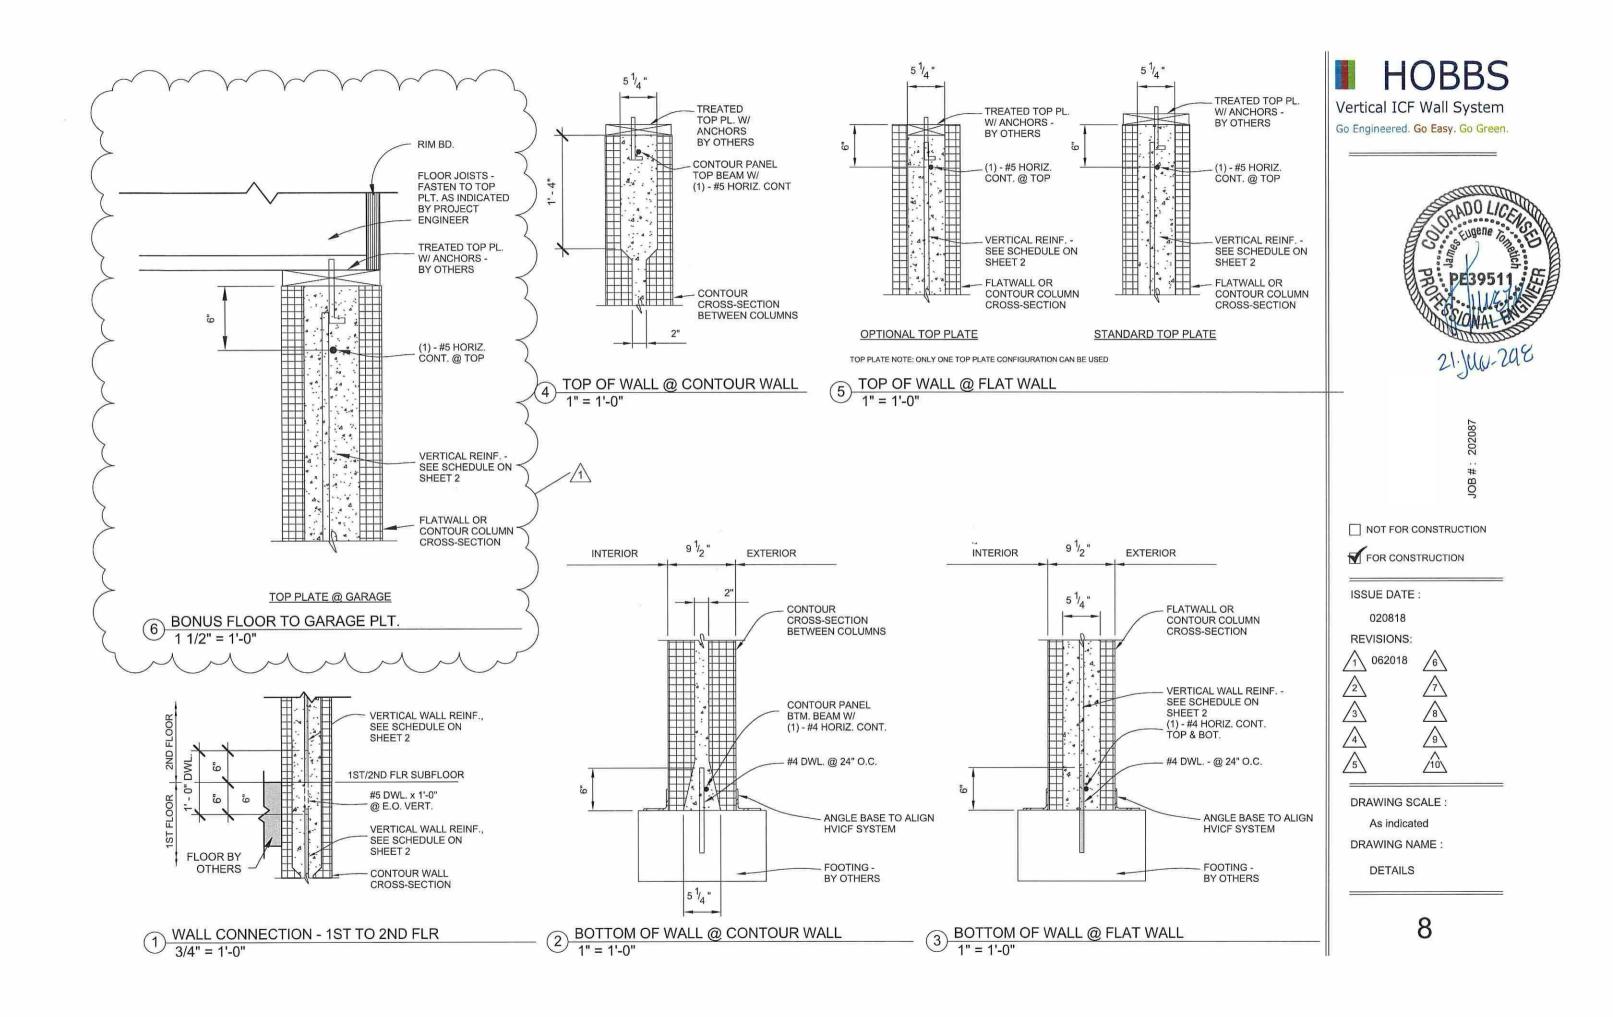

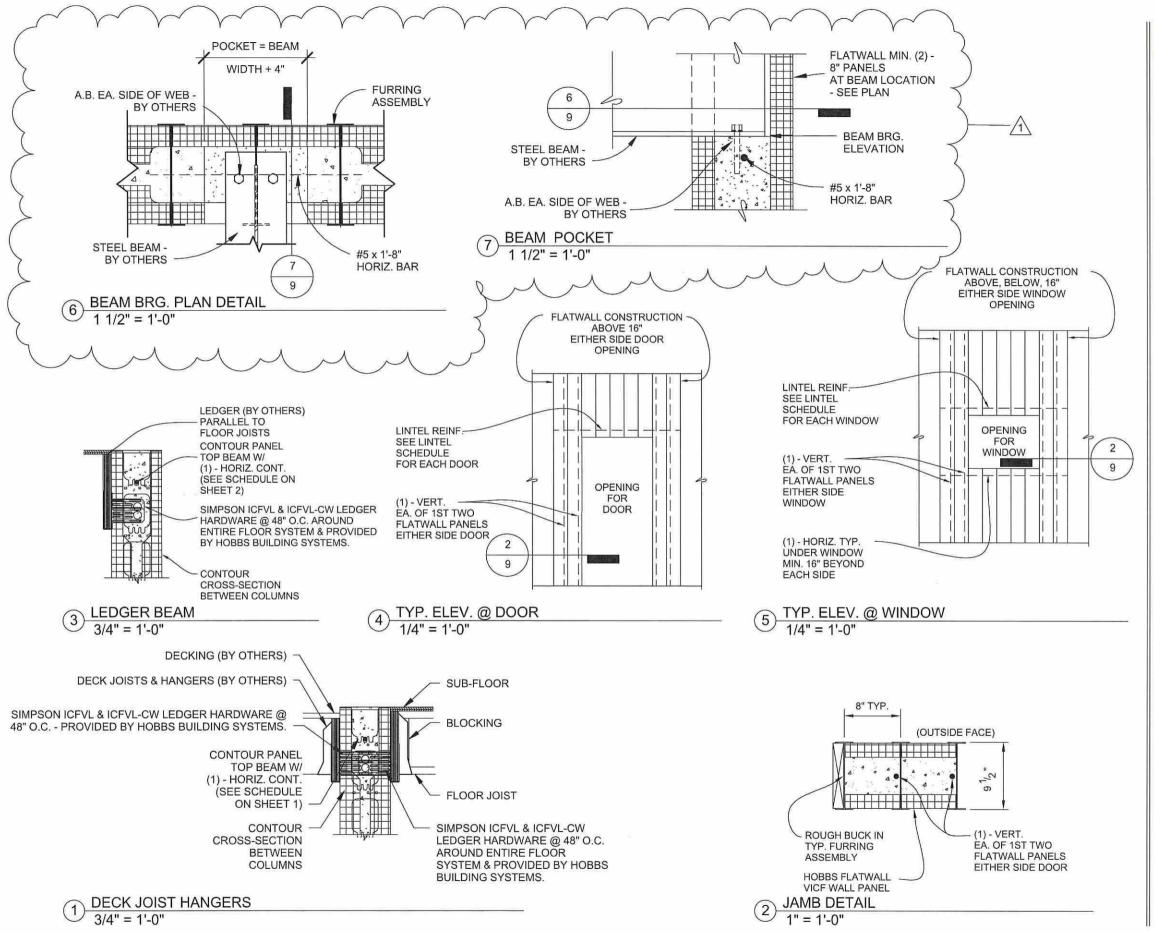

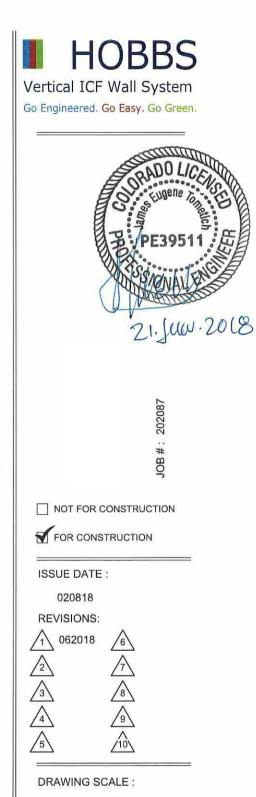

As indicated

..........

DRAWING NAME:

DETAILS