

Vertical ICF Wall System

Go Engineered. Go Easy. Go Green.

Standard Contour Design **Technical Drawings**

Toll free: 866-904-9255

info@hobbsverticalicf.com / www.hobbsverticalicf.com

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TIP: We recommend you watch the slideshow at www.hobbsverticalicf.com before viewing these documents



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Date: 05/08/2009 Revision #:	S.K.V.	N.T.S.

LEGEND

FOAM PANEL PARTS (FP)

FP-SC = STANDARD CONTOUR FOAM PANEL

FP-FW = FLATWALL FOAM PANEL

FP-OC = OUTSIDE CORNER

FP-IC = INSIDE CORNER

FP-OS = OFFSET CORNER

FP-TW = TEE WALL

FP-TT = TAPER TOP



FURRING ASSEMBLY & ACCESSORIES (FA)

FA-ST = FURRING ASSEMBLY

FA-RC = RETAINER CLIP

FA-AB = ANGLE BASE

FA-OC-M = OUTSIDE CORNER METAL


FA-IC-M = INSIDE CORNER METAL

FA-OS-M = OFFSET CORNER METAL



EXAMPLE:

COMPONENTS REQUIRED TO MAKE A 90 deg. CORNER ASSEMBLY

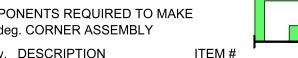

Qty. DESCRIPTION

Outside Corner Foam Panel.

Inside Corner Foam Panel.

Outside Corner Metal. 1

1 Inside Corner Metal.

2 Furring Assembly.

Retainer Clips.

FP-OC-SR-90-9.00*

FP-IC-90-9.00*

FA-OC-M-90-9.00*

FA-IC-M-90-9.00*

FA-ST-9.00*

FA-RC

* Example of 9' wall.

EXAMPLE:

COMPONENTS REQUIRED TO MAKE A 4" OFFSET CORNER ASSEMBLY



Qty. DESCRIPTION

Outside Corner Foam Panel.

Inside Corner Foam Panel.

Outside Corner Metal. 1

1 Inside Corner Metal.

2 Furring Assembly.

Retainer Clips.

FP-OC-SR-90-4OS-9.00*

FP-IC-90-4OS-9.00*

FA-OC-M-90-4OS-9.00* FA-IC-M-90-4OS-9.00*

FA-ST-9.00*

FA-RC

* Example of 9' wall.

EXAMPLE:

COMPONENTS REQUIRED TO MAKE A TEE WALL ASSEMBLY

Qty. DESCRIPTION

ITEM#



- Inside Corner Foam Panels.
- Inside Corner Metal.
- Furring Assemblies.

12 Retainer Clips.

FP-TW-SR-9.00*

FP-IC-90-9.00*

FA-IC-M-90-9.00*


FA-ST-9.00*

FA-RC

* Example of 9' wall.

EXAMPLE:

COMPONENTS REQUIRED TO MAKE A 45 deg. CORNER ASSEMBLY

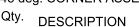

ITEM#

Outside Corner Foam Panel. Inside Corner Foam Panel.

Outside Corner Metal. 1

Inside Corner Metal.

2 Furring Assembly.

Retainer Clips.

FP-OC-SR-45-9.00* FP-IC-45-9.00*

FA-OC-M-45-9.00*

FA-IC-M-45-9.00*

FA-ST-9.00*

FA-RC

* Example of 9' wall.



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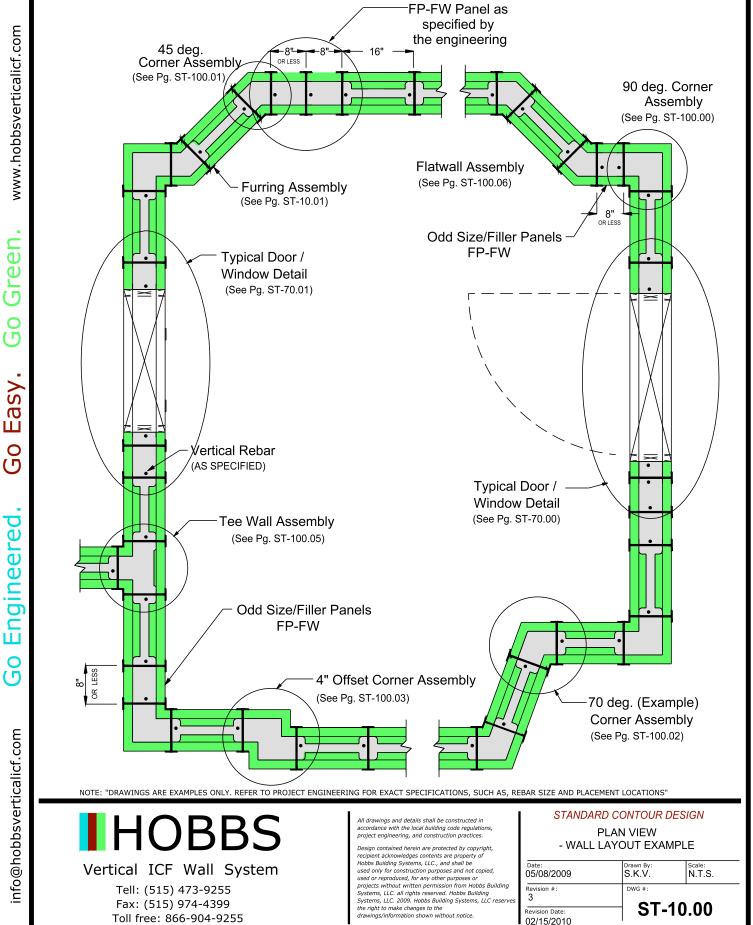
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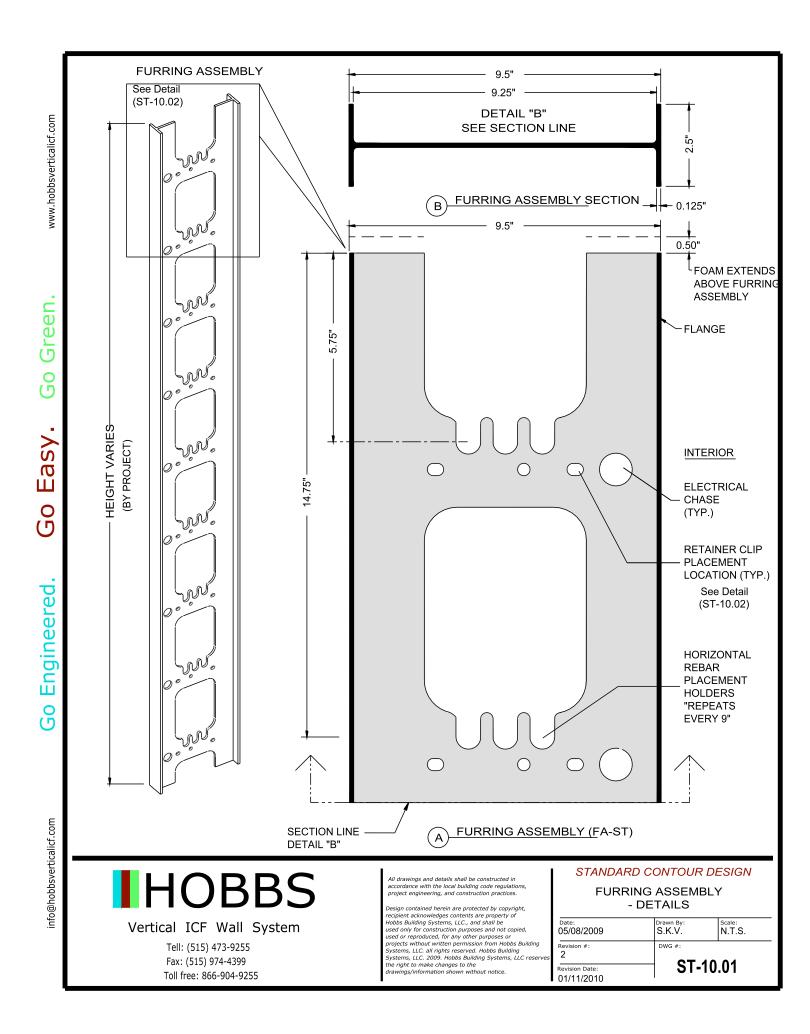
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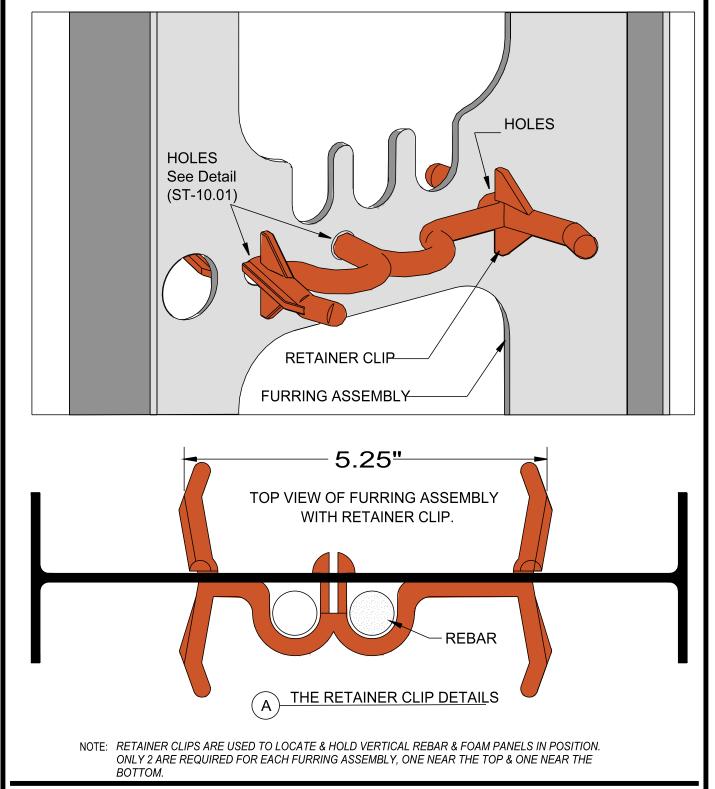
LEGEND

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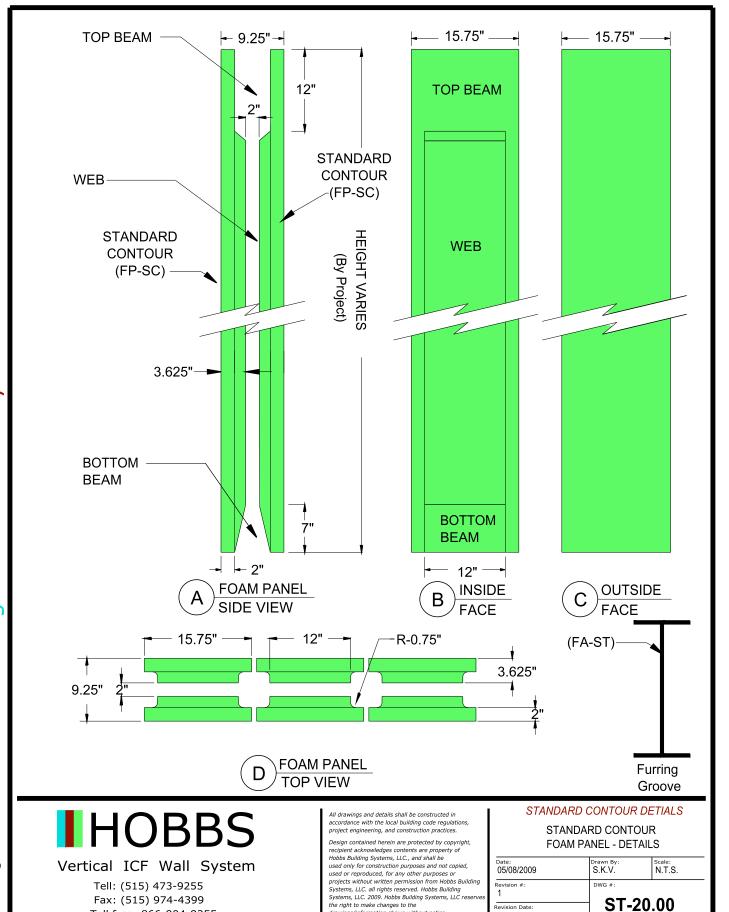
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RETAINER CLIP DETAILS


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Revision #:	DWG #:	10.00	
Revision Date: 01/11/2010	51-	ST-10.02	


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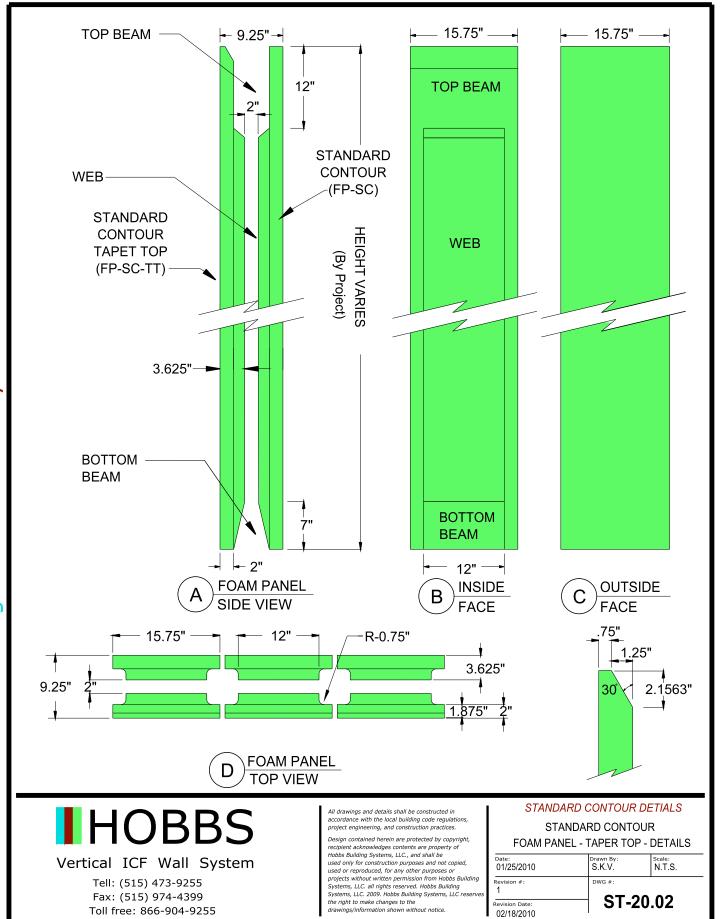


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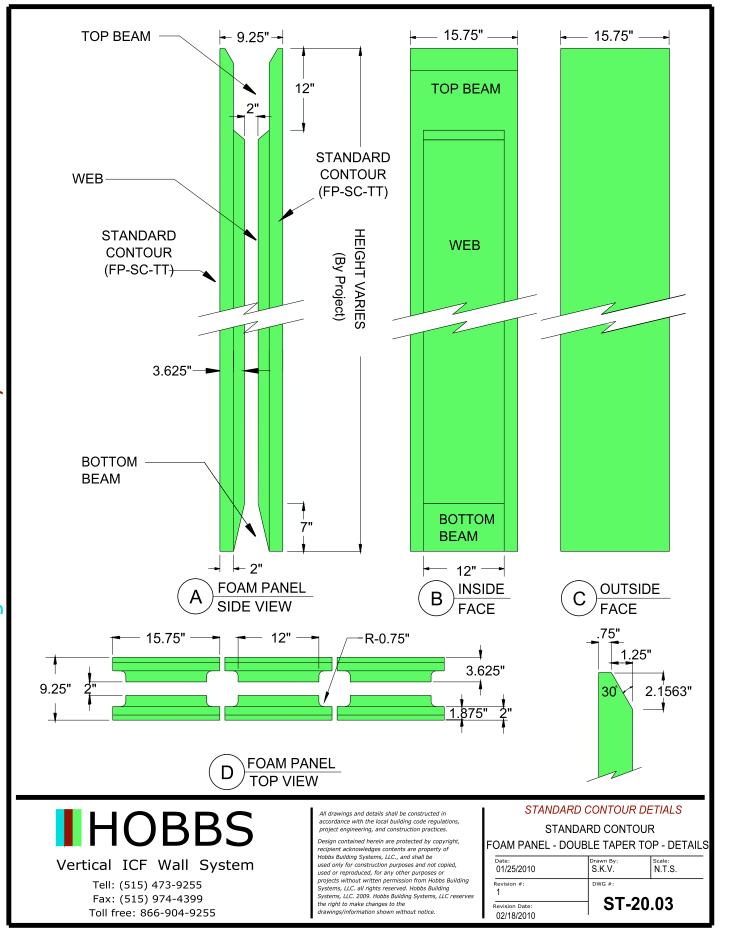
12/11/2009






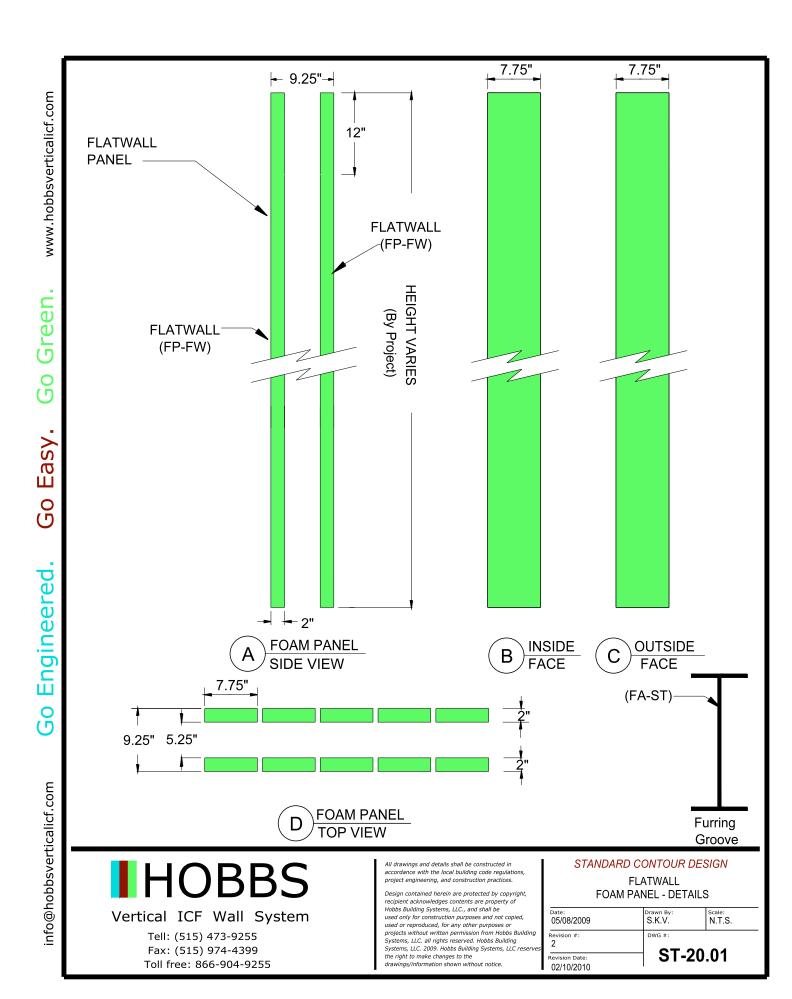

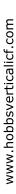








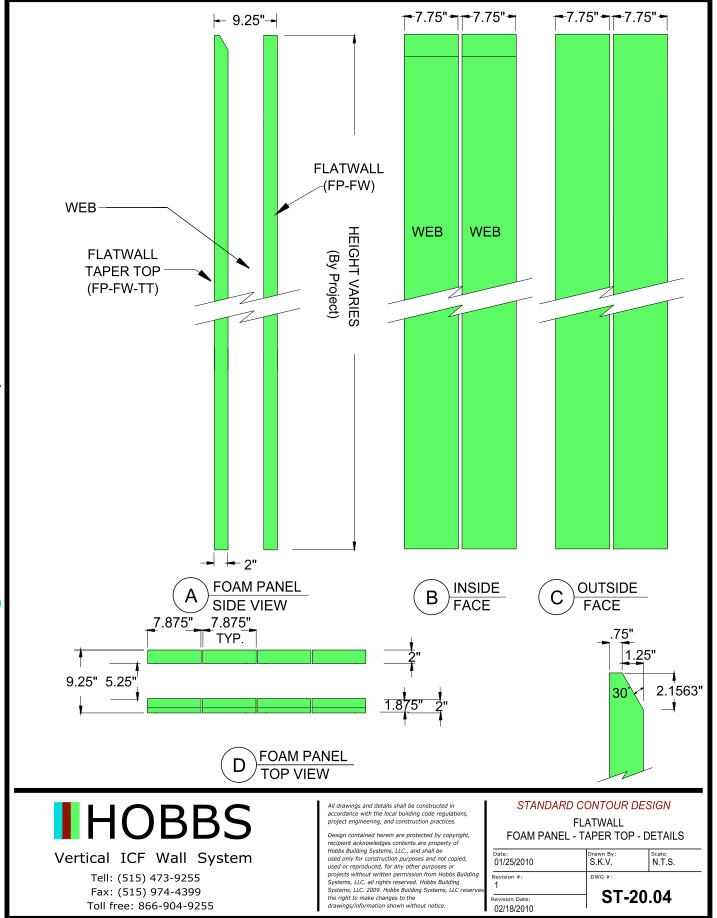



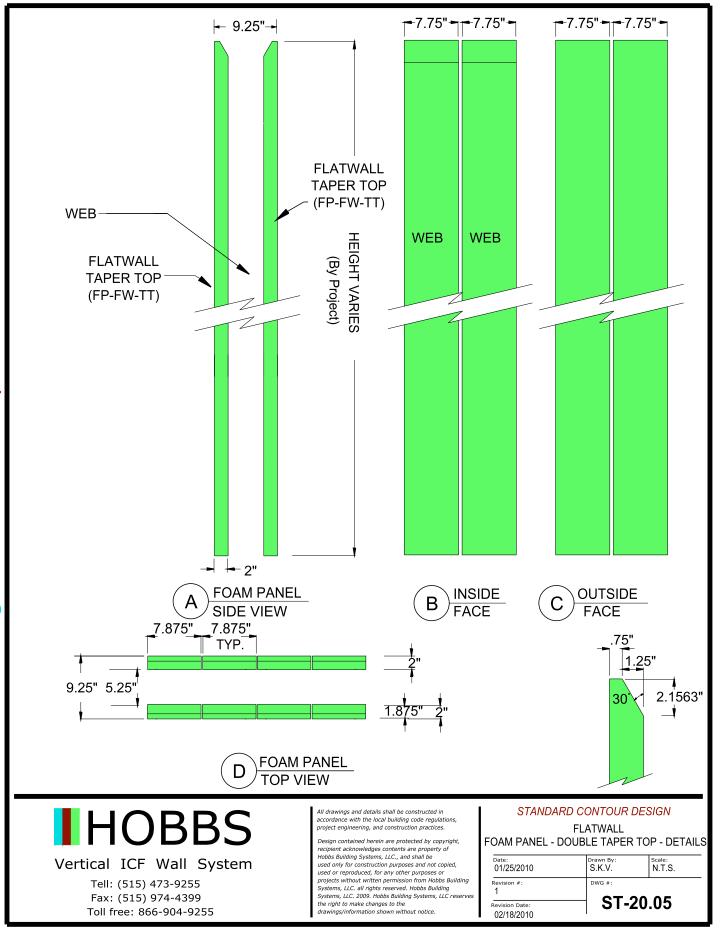

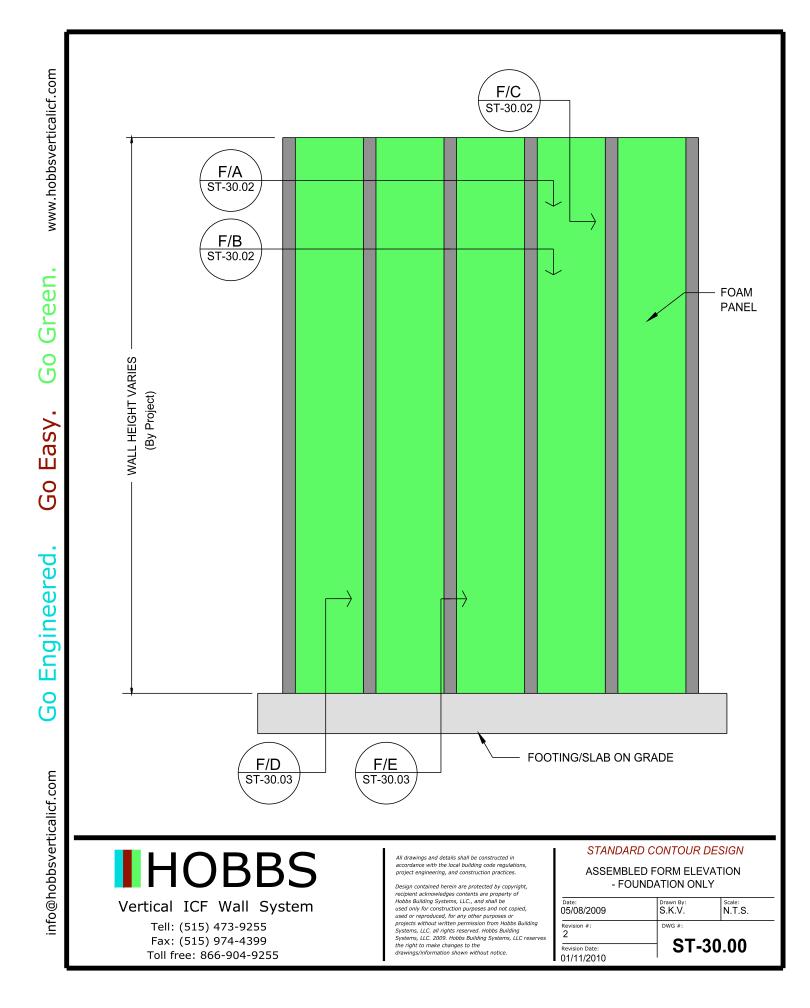

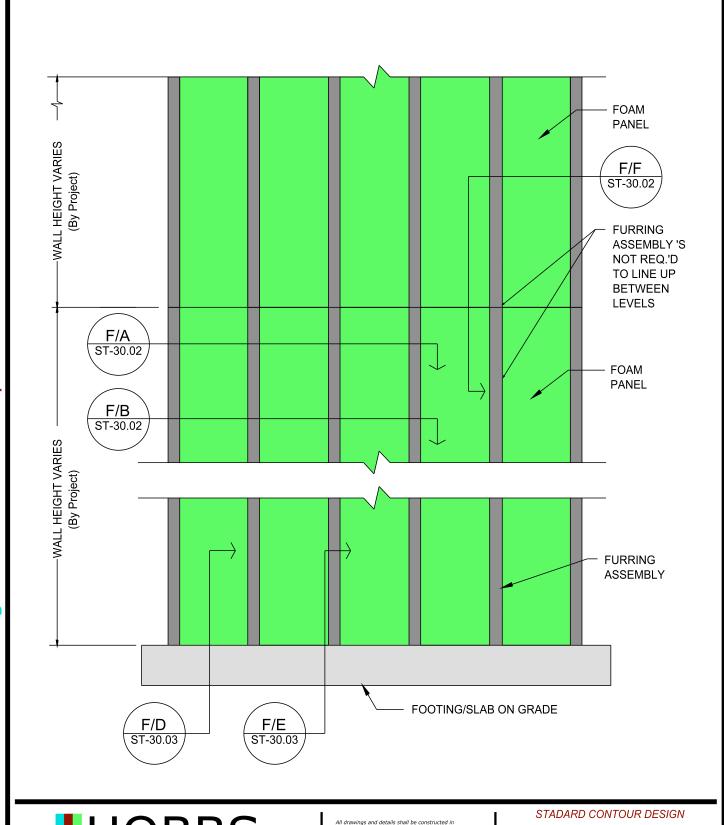

HOBBS

Vertical ICF Wall System


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ASEMBLED FORM ELEVATION - MULTI LEVEL

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Revision #:	DWG #:	20.04	
Revision Date: 01/11/2010	<u> </u>	ST-30.01	

12"



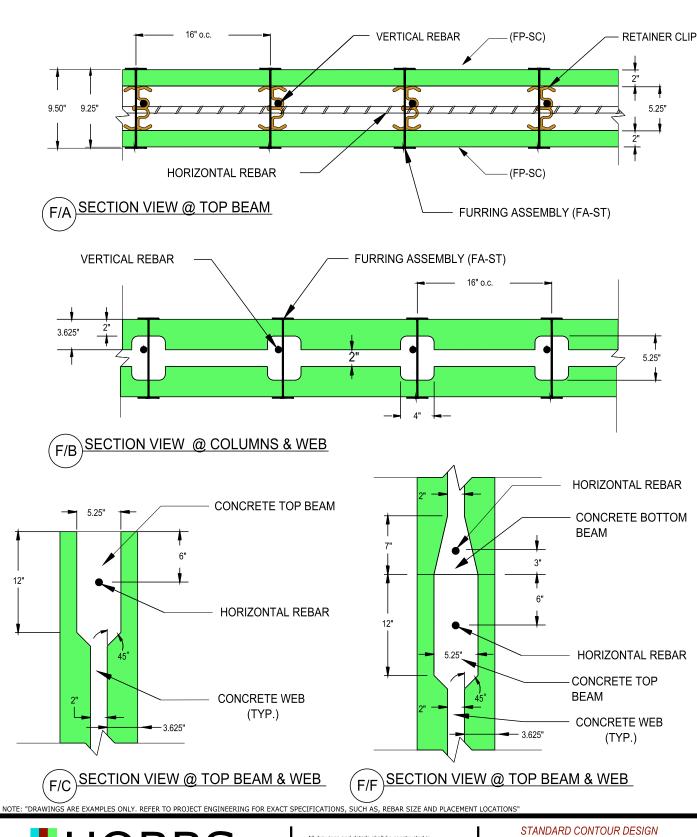

Vertical ICF Wall System


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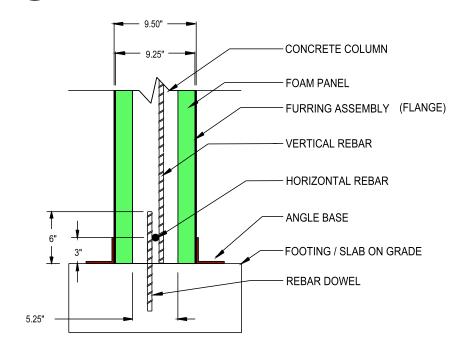
ASSEMBLED FORM

- SECTIONS F,G,H,&I

Date: 05/08/2009	Drawn By: S.K.V.	Scale: N.T.S.	
Revision #:	DWG #:		
Revision Date: 01/11/2010	SI-	ST-30.02	



SECTION VIEW @ BOTTOM BEAM & WEB

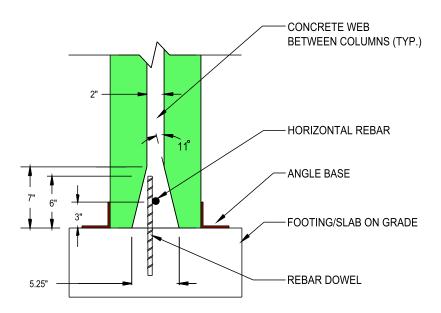

SECTION VIEW @ BOTTOM BEAM & COLUMN

NOTE: "DRAWINGS ARE EXAMPLES ONLY, REFER TO PROJECT ENGINEERING FOR EXACT SPECIFICATIONS, SUCH AS, REBAR SIZE AND PLACEMENT LOCATIONS"



Vertical ICF Wall System


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ASSEMBLE FORM - SECTION J & K

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Revision #:	DWG #:	00.00	
Revision Date: 01/11/2010	<u> </u>	ST-30.03	




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CUT-AWAY ELEVATION - FOUNDATION ONLY

Date: 05/08/2009 Scale: N.T.S. S.K.V. ST-40.00 1/11/2010

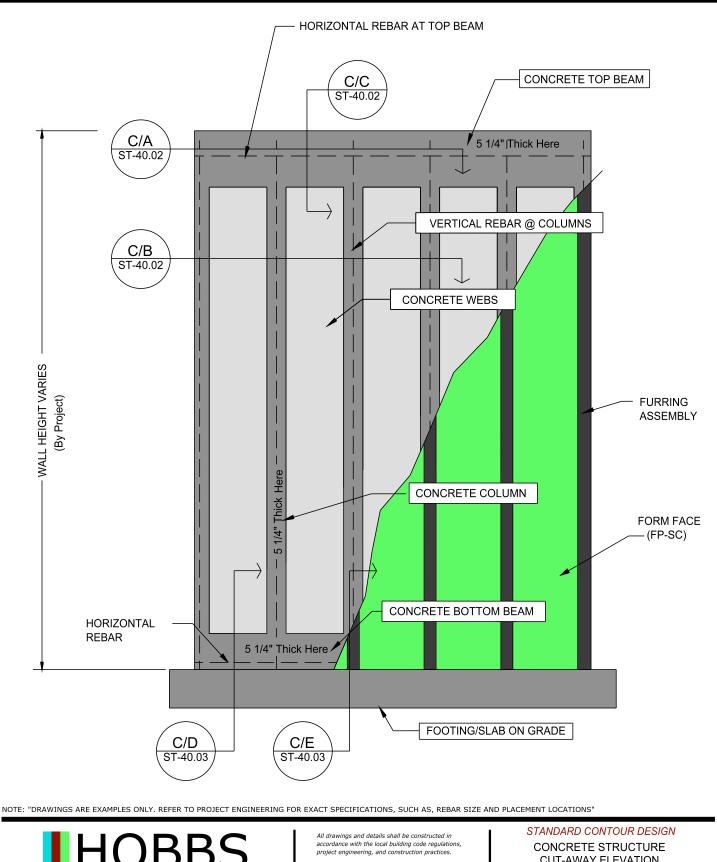

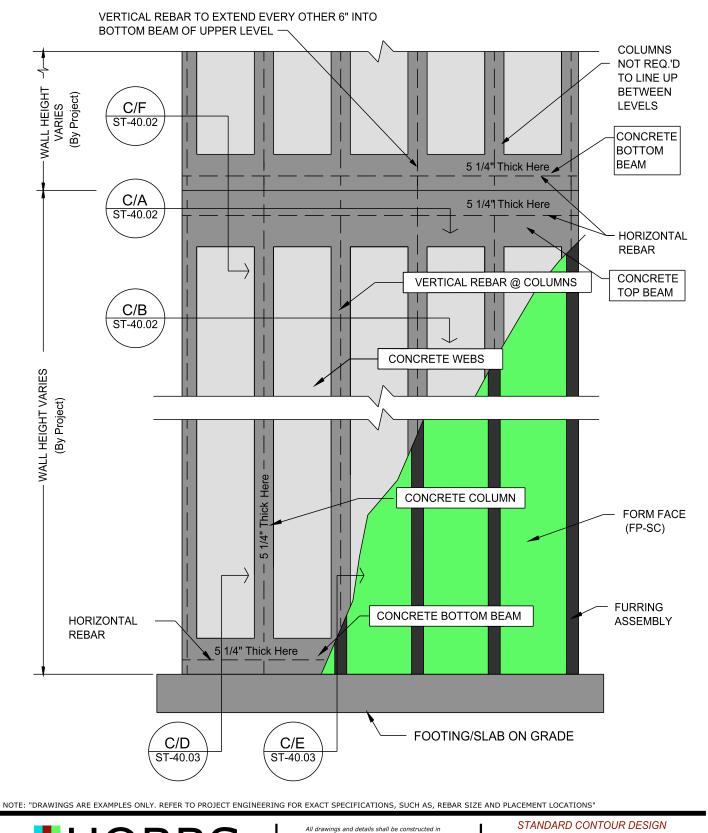

Vertical ICF Wall System


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CONCRETE STRUCTURE CUT-AWAY ELEVATION - MULTI LEVEL

FORM -

C/C



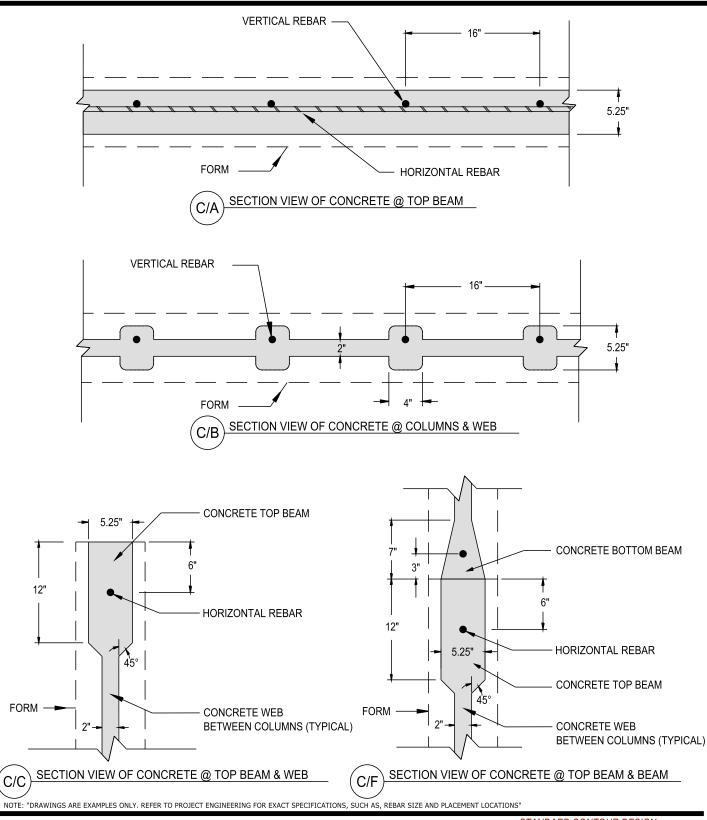

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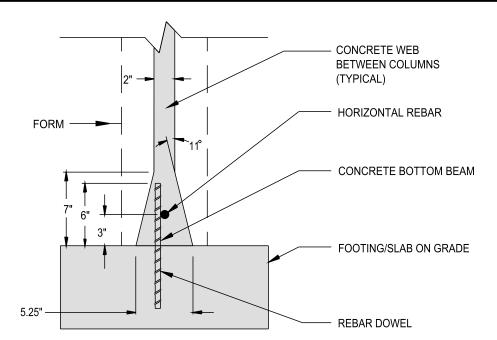
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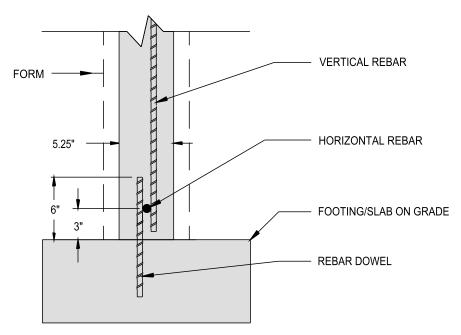
CONCRETE SECTIONS A, B, C, & D

- WITHOUT FORMS S.K.V.

Date: 05/08/2009 Scale: N.T.S. DWG #: ST-40.02 01/11/2010



C/D SECTION VIEW @ BOTTOM BEAM & WEB



C/E SECTION VIEW @ COLUMN

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Vertical ICF Wall System


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CONCRETE SECTIONS E & F - WITHOUT FORMS


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Revision Date: 02/23/2010	51-4	ST-40.04	



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Vertical ICF Wall System


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FOUNDATION ONLY WALL SECTION @ COLUMN
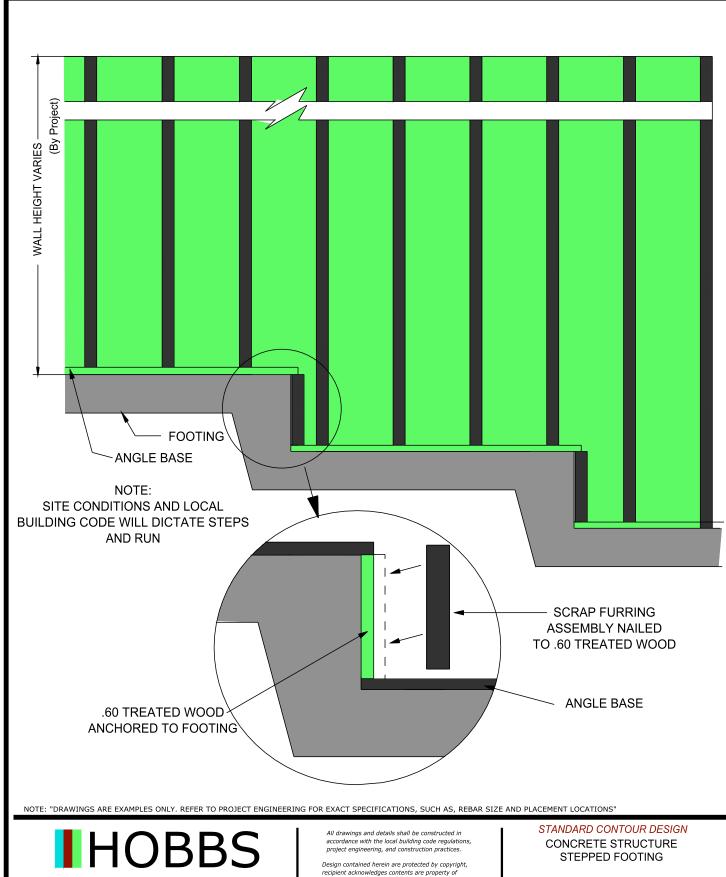
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Revision Date: 12/11/2009	51-	ST-50.00	

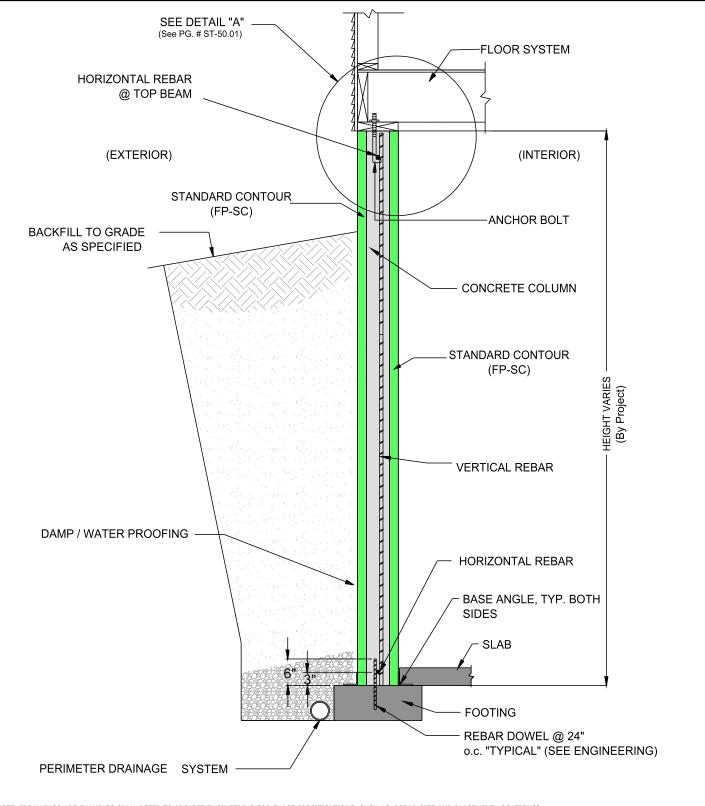

FOUNDATION ONLY WALL SECTION @ COLUMN - DETAIL "A"

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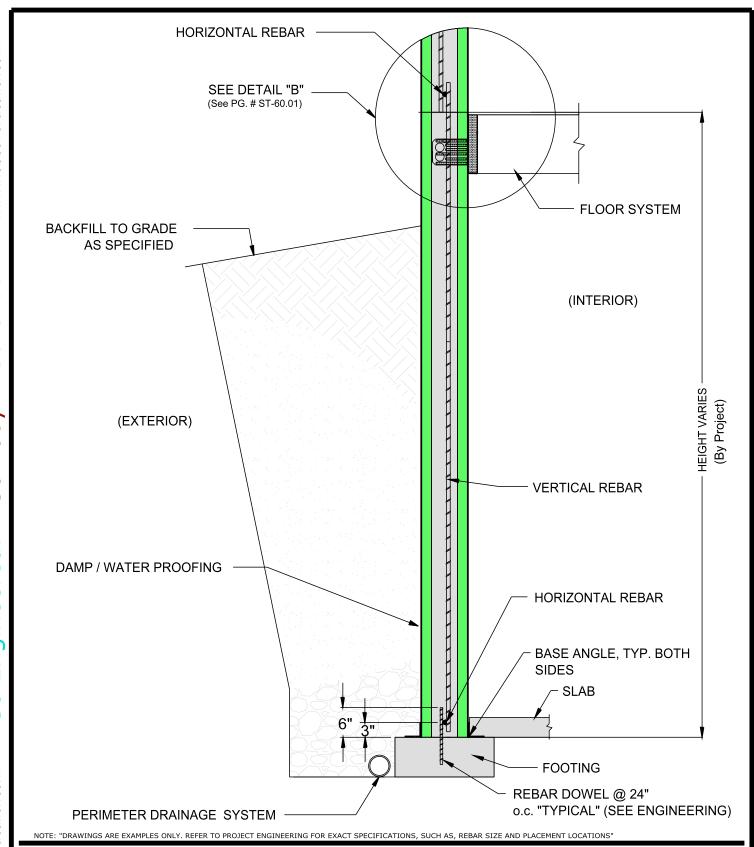
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STANDARD CONTOUR DESIGN FOUNDATION ONLY

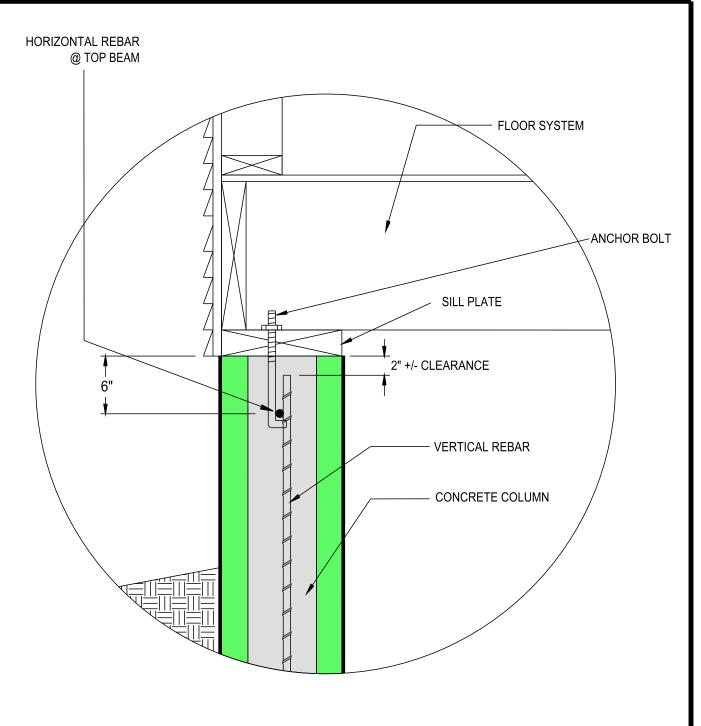WALL SECTION @
COLUMN - DETAIL "A"



IHOBBS

Vertical ICF Wall System


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STANDARD CONTOUR DESIGN

FOUNDATION & UPPER LEVEL WALL SECTION @ COLUMN

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Revision #: 1	DWG #:	E0 00	
Revision Date: 12/11/2009	51-	ST-50.02	



FOUNDATION & UPPER LEVEL @ COLUMN - DETAIL "B"
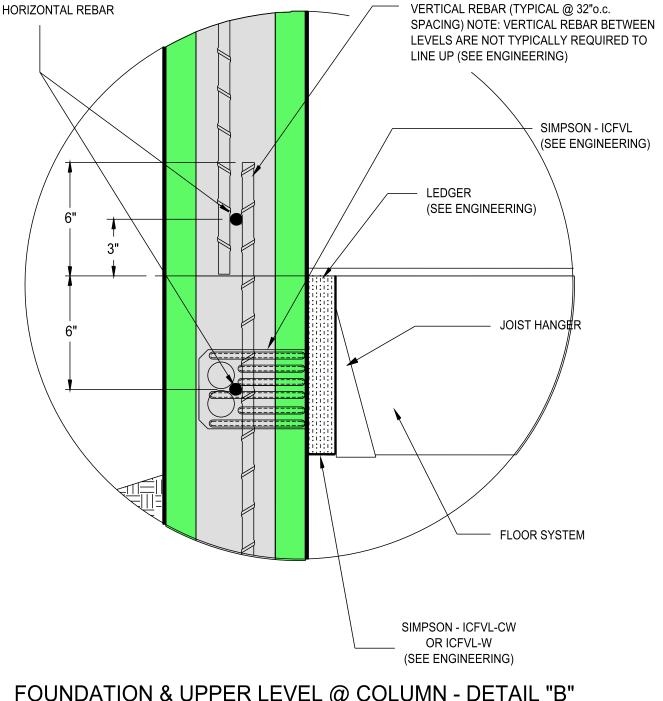
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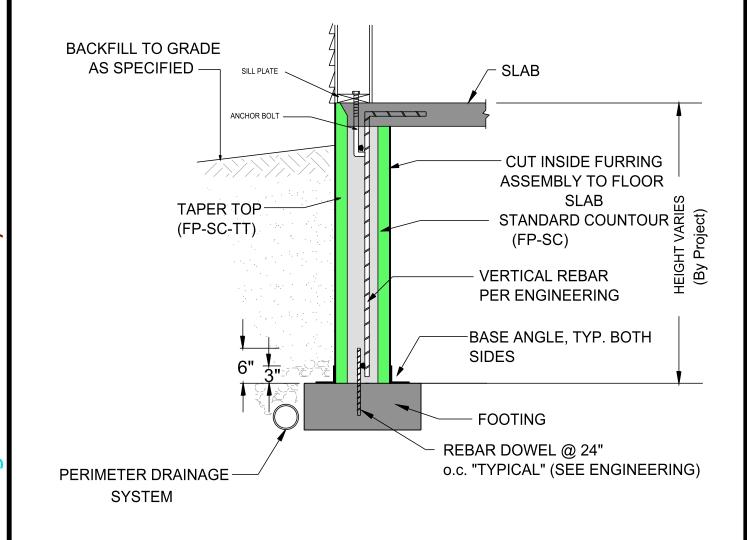
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STANDARD CONTOUR DESIGN

FOUNDATION & UPPER LEVEL WALL SECTION

@ COLUMN - DETAIL "B"

Date: 05/08/2009	S.K.V.	N.T.S.
Revision #:	DWG #:	-0.00
Revision Date: 12/11/2009	<u> </u>	50.03



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Vertical ICF Wall System


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STANDARD CONTOUR AND TAPER TOP DESIGN

CONCRETE SLAB LEDGE @ COLUMN

@ COLOWIN			
Date: 05/08/2009	Drawn By: S.K.V.	Scale: N.T.S.	
Revision #:	DWG #:	50.04	
Revision Date: 02/19/2010	<u> </u>	50.04	



REINFORCED CONCRETE FLOOR

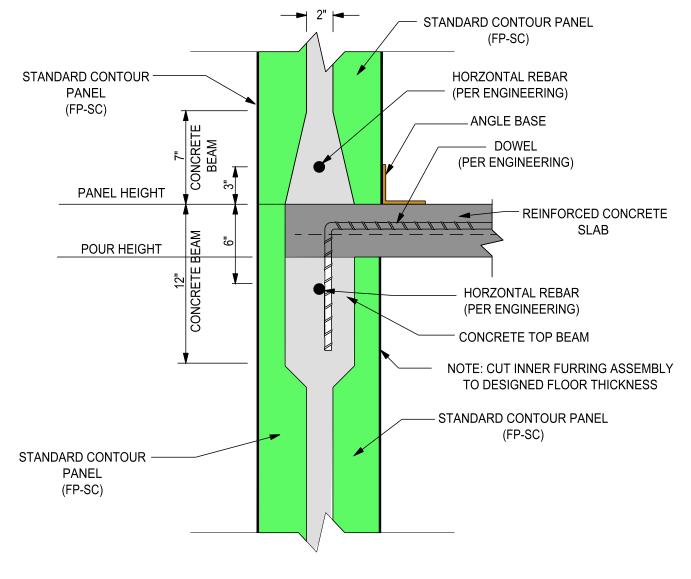SLAB DETAIL @ WEB

NOTE: "DRAWINGS ARE EXAMPLES ONLY. REFER TO PROJECT ENGINEERING FOR EXACT SPECIFICATIONS, SUCH AS, REBAR SIZE AND PLACEMENT LOCATIONS"



Vertical ICF Wall System


Tell: (515) 473-9255 Fax: (515) 974-4399 Toll free: 866-904-9255 All drawings and details shall be constructed in accordance with the local building code regulations, project engineering, and construction practices.

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STANDARD CONTOUR DESIGN

REINFORCED CONCRETE FLOOR SLAB EXTERIOR DETAIL @ WEB

Date: 05/08/2009	Drawn By: S.K.V.	Scale: N.T.S.
Revision #: 1	DWG #:	0.5
Revision Date: 02/19/2010	ST-50	.05

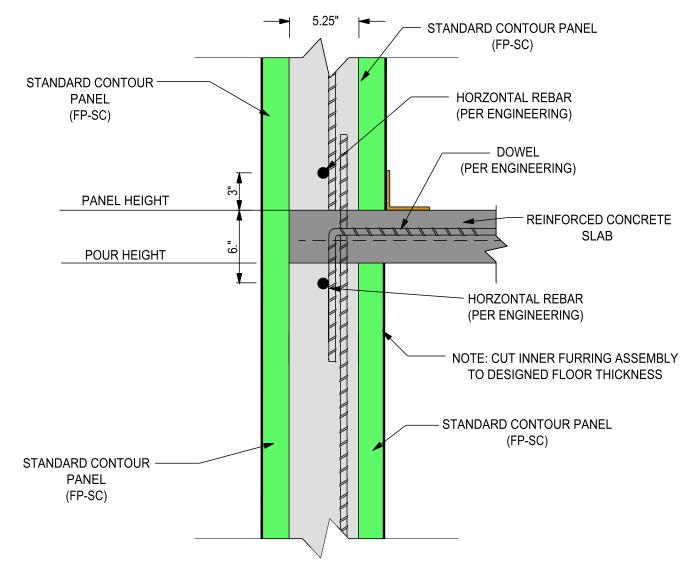

REINFORCED CONCRETE FLOOR SLAB DETAIL @ COLUMN EXTERIOR

NOTE: "DRAWINGS ARE EXAMPLES ONLY. REFER TO PROJECT ENGINEERING FOR EXACT SPECIFICATIONS, SUCH AS, REBAR SIZE AND PLACEMENT LOCATIONS"



Vertical ICF Wall System


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STANDARD CONTOUR DESIGN

REINFORCED CONCRETE FLOOR SLAB EXTERIOR DETAIL @ COLUMN

Date: 05/08/2009	Drawn By: S.K.V.	Scale: N.T.S.
Revision #: 1	DWG #:	00
Revision Date: 02/19/2010	ST-50	.06



REINFORCED CONCRETE FLOOR SLAB DETAIL @ WEB

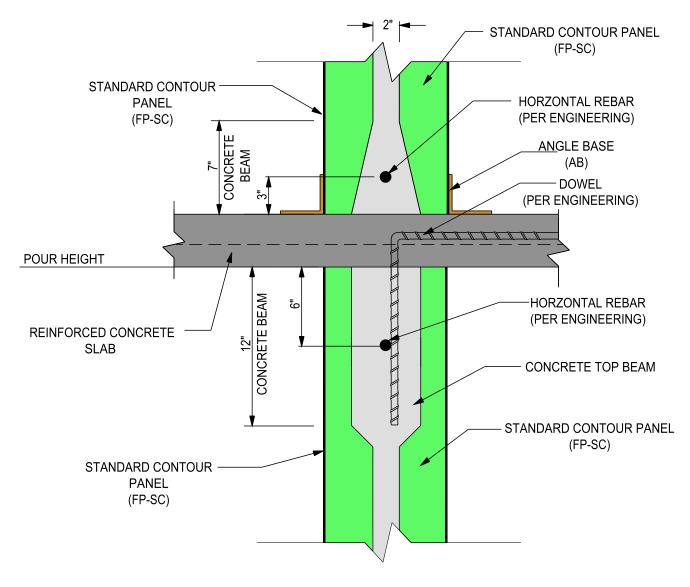INTERIOR

NOTE: "DRAWINGS ARE EXAMPLES ONLY. REFER TO PROJECT ENGINEERING FOR EXACT SPECIFICATIONS, SUCH AS, REBAR SIZE AND PLACEMENT LOCATIONS"



Vertical ICF Wall System


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STANDARD CONTOUR DESIGN

REINFORCED CONCRETE FLOOR SLAB INTERIOR DETAIL @ WEB

Date: 05/08/2009	Drawn By: S.K.V.	Scale: N.T.S.
Revision #: 1	DWG #:	0.7
Revision Date: 01/19/2010	ST-50	.07



REINFORCED CONCRETE FLOOR SLAB DETAIL @ COLUMN INTERIOR

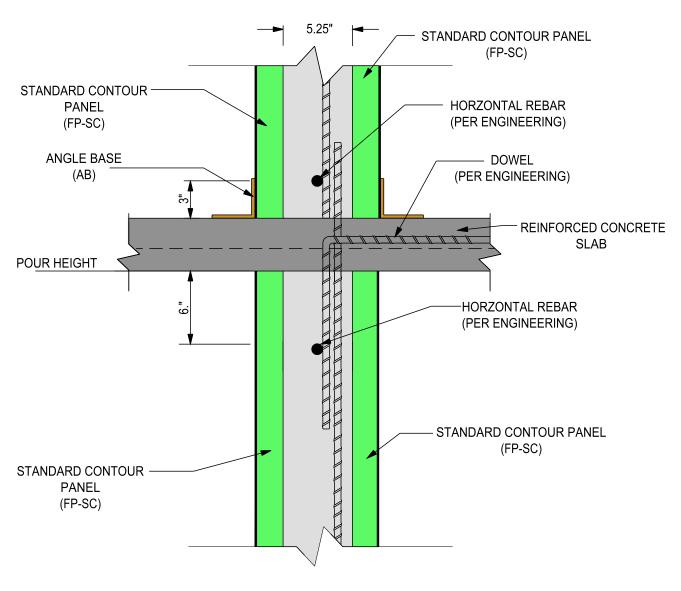NOTE: "DRAWINGS ARE EXAMPLES ONLY. REFER TO PROJECT ENGINEERING FOR EXACT SPECIFICATIONS, SUCH AS, REBAR SIZE AND PLACEMENT LOCATIONS"



Vertical ICF Wall System


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REINFORCED CONCRETE FLOOR SLAB INTERIOR DETAIL @ COLUMN

Date: 05/08/2009	Drawn By: S.K.V.	Scale: N.T.S.	
Revision #:	DWG #:		
Revision Date: 01/19/2010	ST-	ST-50.08	



BEAM POCKET @ COLUMN

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Vertical ICF Wall System

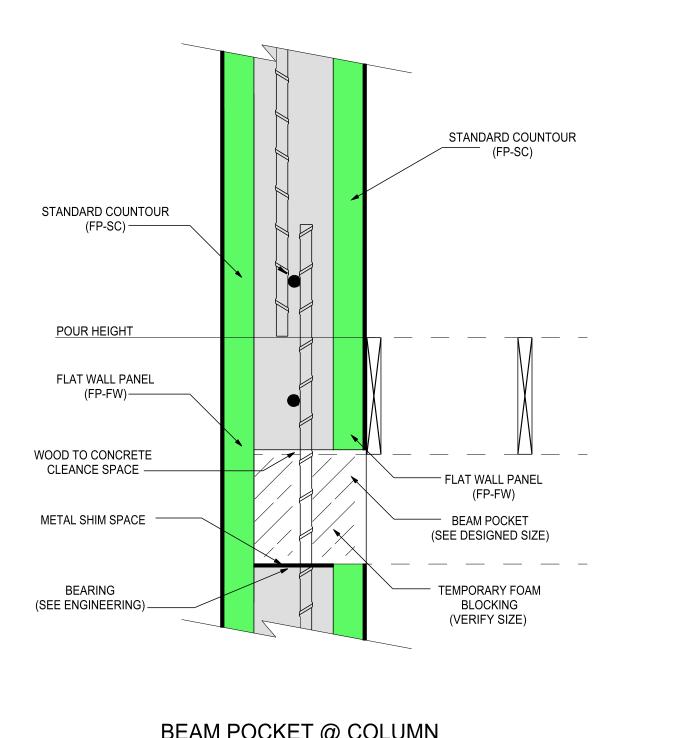
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STANDARD CONTOUR DESIGN

BEAM POCKET @ **COLUMN**

Date: 05/08/2009	S.K.V.	Scale: N.T.S.	
Revision #:	DWG #:	50.00	
Revision Date: 02/19/2010	<u> </u>	ST-50.09	



PARTY WALL JOIST PERPENDICULAR @ COLUMN

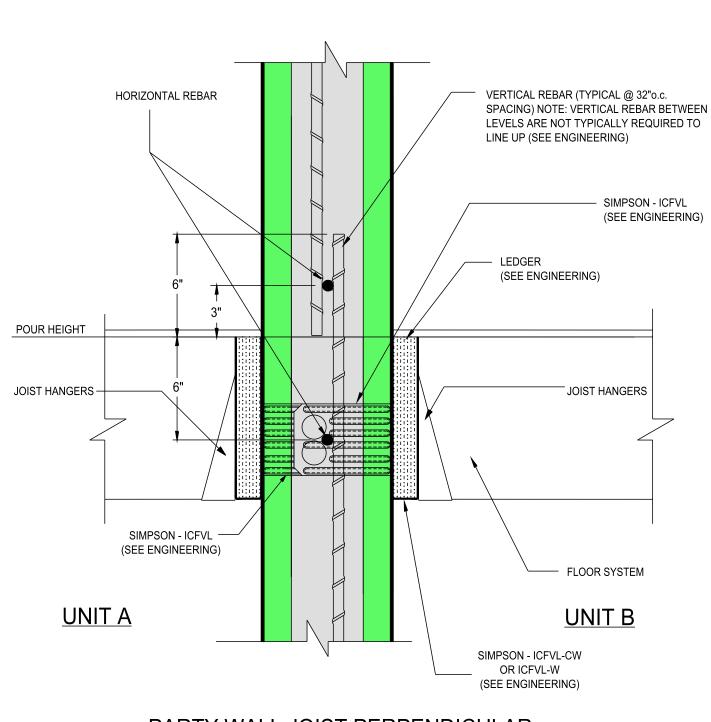NOTE: "DRAWINGS ARE EXAMPLES ONLY. REFER TO PROJECT ENGINEERING FOR EXACT SPECIFICATIONS, SUCH AS, REBAR SIZE AND PLACEMENT LOCATIONS"



Vertical ICF Wall System


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STANDARD CONTOUR DESIGN

PARTY WALL JOIST PERPENDICULAR @ COLUMN

Date: 05/08/2009	Drawn By: S.K.V.	Scale: N.T.S.
Revision #: 1	DWG #:	40
Revision Date: 02/19/2010	ST-50	.10



@ COLUMN

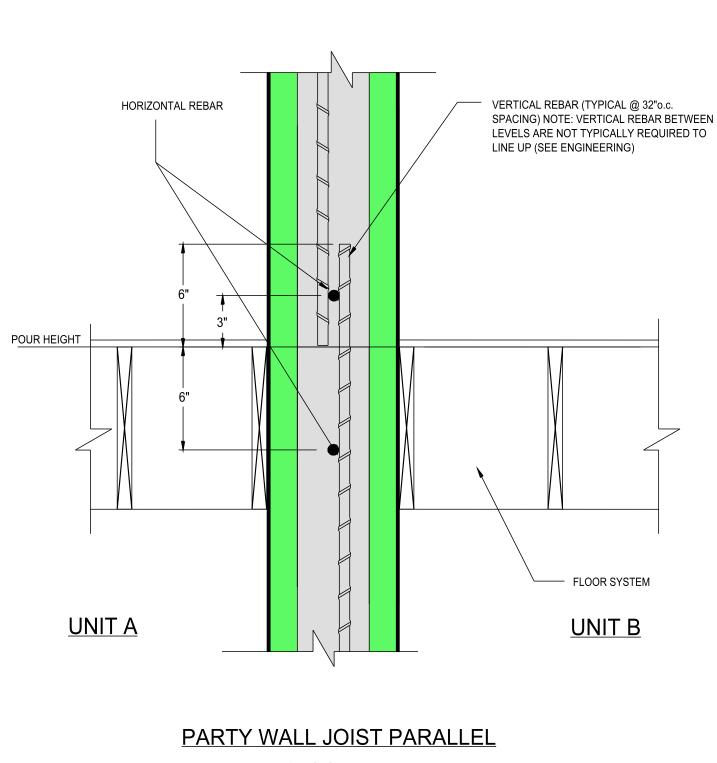NOTE: "DRAWINGS ARE EXAMPLES ONLY. REFER TO PROJECT ENGINEERING FOR EXACT SPECIFICATIONS, SUCH AS, REBAR SIZE AND PLACEMENT LOCATIONS"



Vertical ICF Wall System


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STANDARD CONTOUR DESIGN

PARTY WALL JOIST PARALLEL @ COLUMN

Drawn By S.K.V. Scale: N.T.S. 05/08/2009 DWG #: ST-50.11 02/19/2010




IHOBBS

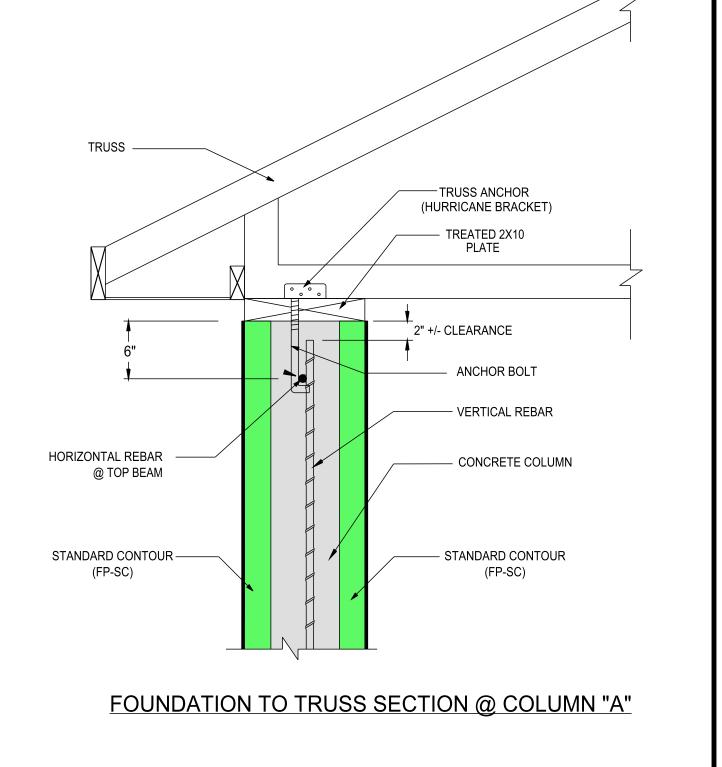Vertical ICF Wall System

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STANDARD CONTOUR DESIGN FOUNDATION TO TRUSS SECTION @ COLUMN "A"



FOUNDATION TO TRUSS SECTION @ COLUMN "B"

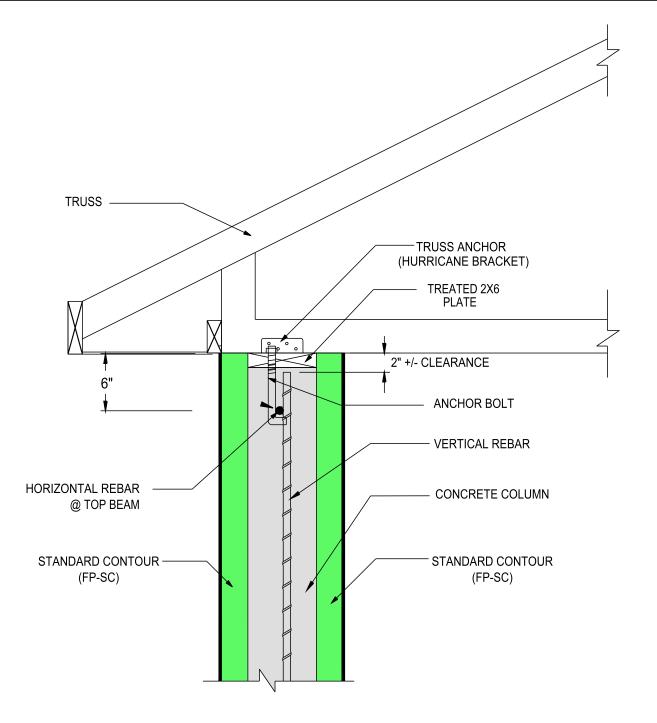NOTE: "DRAWINGS ARE EXAMPLES ONLY. REFER TO PROJECT ENGINEERING FOR EXACT SPECIFICATIONS, SUCH AS, REBAR SIZE AND PLACEMENT LOCATIONS




Vertical ICF Wall System

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STANDARD CONTOUR DESIGN FOUNDATION TO TRUSS SECTION @ COLUMN "B"



HORRC

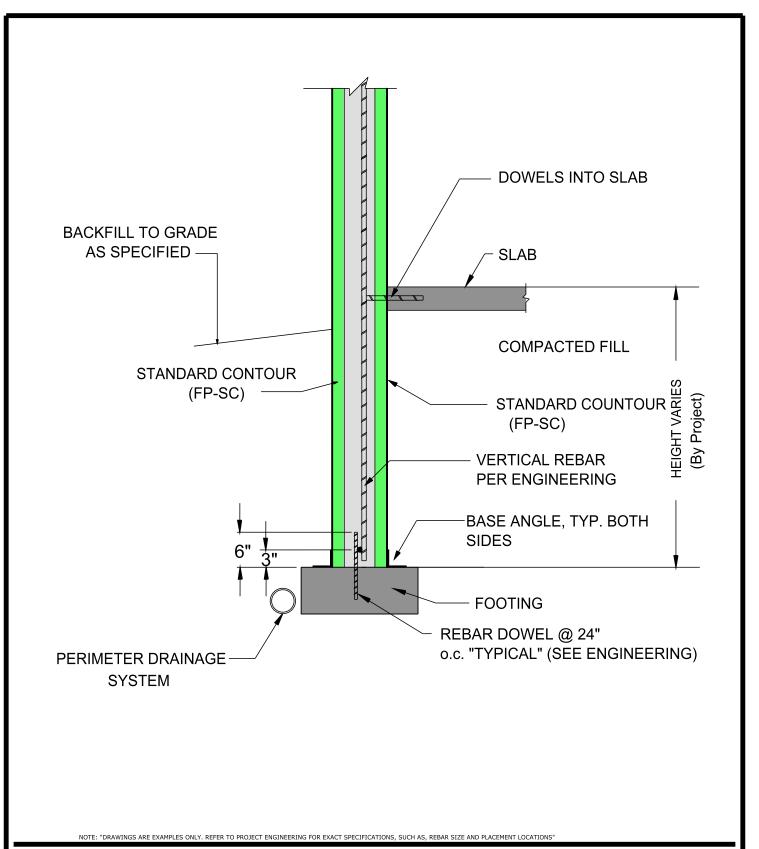Vertical ICF Wall System


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STANDARD CONTOUR CONCRETE SLAB @ COLUMN

Date: 05/08/2009 S.K.V. Scale: N.T.S.

Revision #: 1 BREVISION Date: 02/19/2010 ST-50.14



FOUNDATION ONLY WALL SECTION @ COLUMN - DETAIL "A"

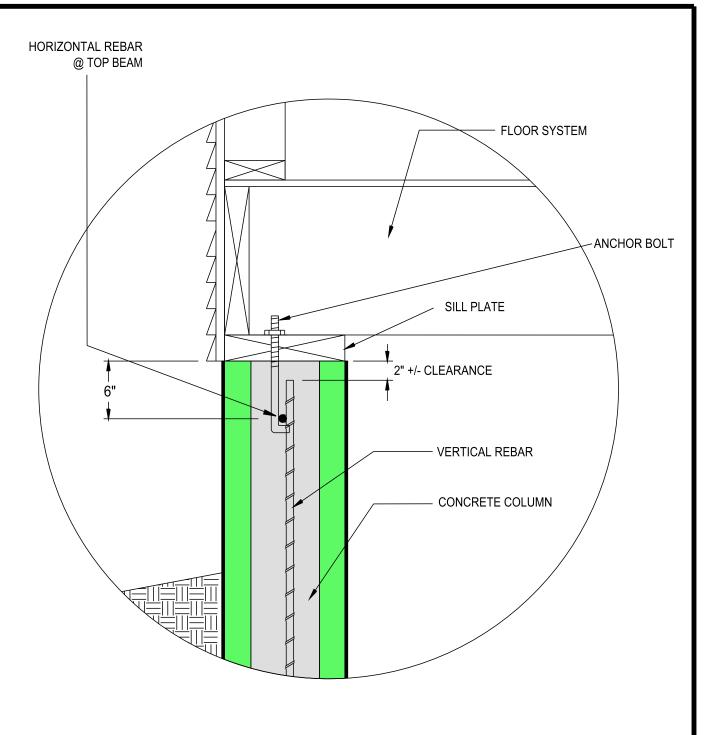NOTE: "DRAWINGS ARE EXAMPLES ONLY. REFER TO PROJECT ENGINEERING FOR EXACT SPECIFICATIONS, SUCH AS, REBAR SIZE AND PLACEMENT LOCATION



Vertical ICF Wall System


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STANDARD CONTOUR DESIGN

FOUNDATION ONLY WALL SECTION @ COLUMN - DETAIL "A"

Date: 05/08/2009	S.K.V.	N.T.S.
Revision #:	DWG #:	0.45
Revision Date: 12/11/2009	ST-50.15	



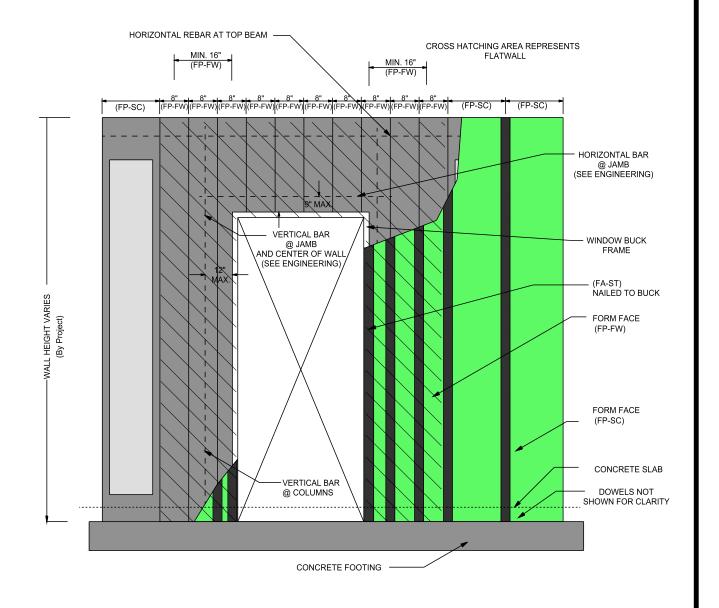

Vertical ICF Wall System


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STANDARD CONTOUR DESIGN

TYPICAL DOOR DETAIL

Date: 12/02/2009	S.K.V.	Scale: N.T.S.	
Revision #:	DWG #:	70.00	
Revision Date: 02/10/2010	SI-	ST-70.00	



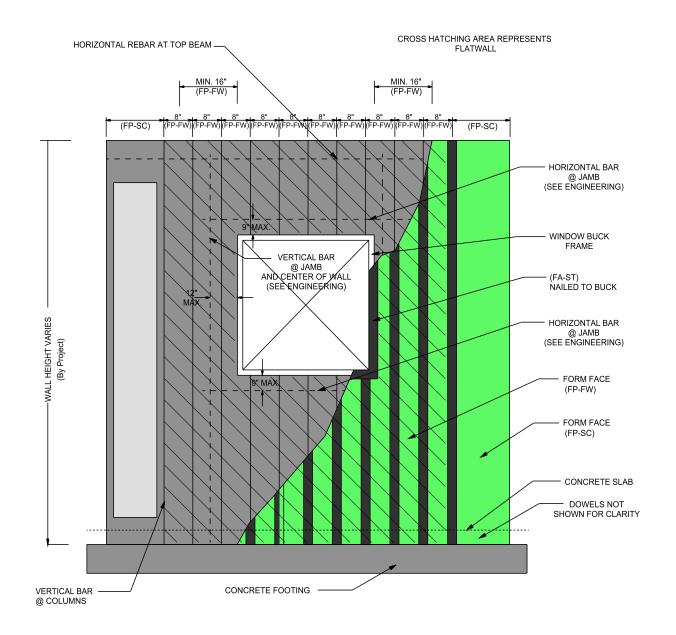

Vertical ICF Wall System


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STANDARD CONTOUR DESIGN

TYPICAL WINDOW DETAIL

Date: 12/02/2009	Drawn By: S.K.V.	Scale: N.T.S.	
Revision #:	DWG #:	70.04	
Revision Date: 02/10/2010	SI-	ST-70.01	



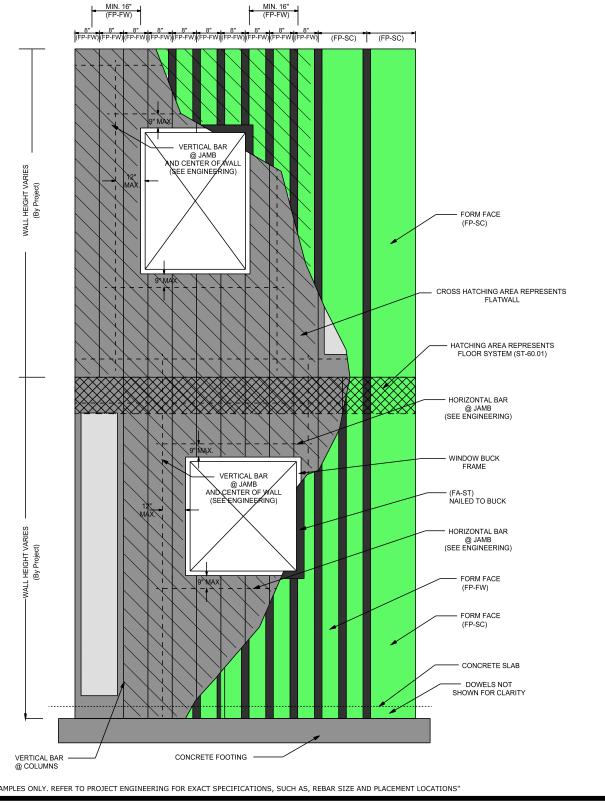

Vertical ICF Wall System


Tell: (515) 473-9255 Fax: (515) 974-4399 Toll free: 866-904-9255 All drawings and details shall be constructed in accordance with the local building code regulations, project engineering, and construction practices.


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STANDARD CONTOUR DESIGN

TYPICAL WINDOW DETAIL

Date: 2/02/2009	Drawn By: S.K.V.	Scale: N.T.S.	
Revision #: 1	DWG #:	70.00	
levision Date: 02/19/2010	<u> </u>	│ ST-70.02	



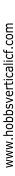


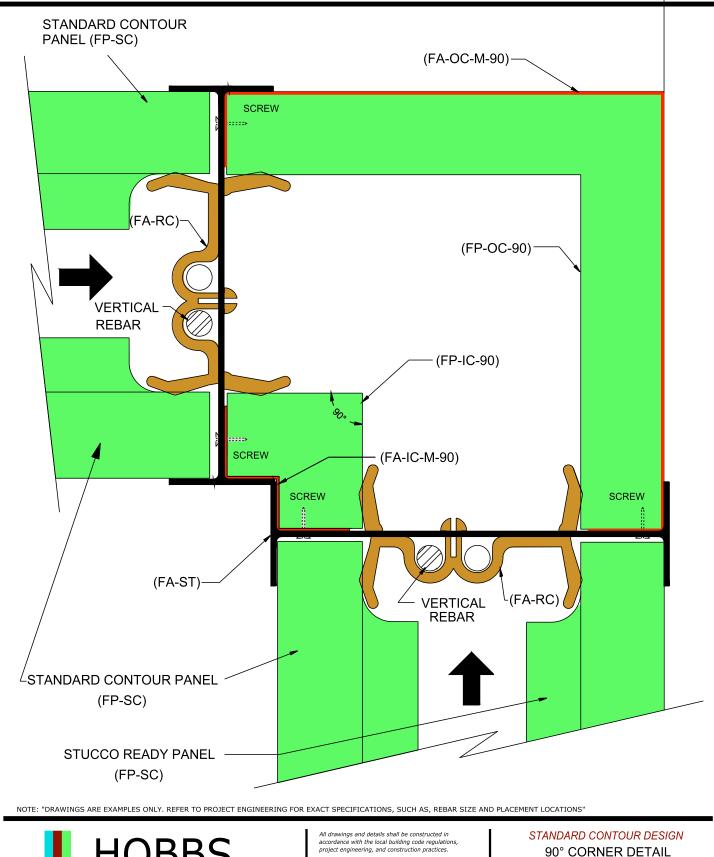HOBBS

Vertical ICF Wall System

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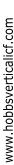
Date: 05/08/2009	Drawn By: S.K.V.	Scale: N.T.S.
Revision #: 1	DWG #:	20.00
Revision Date: 2/11/2009	ST-10	00.00




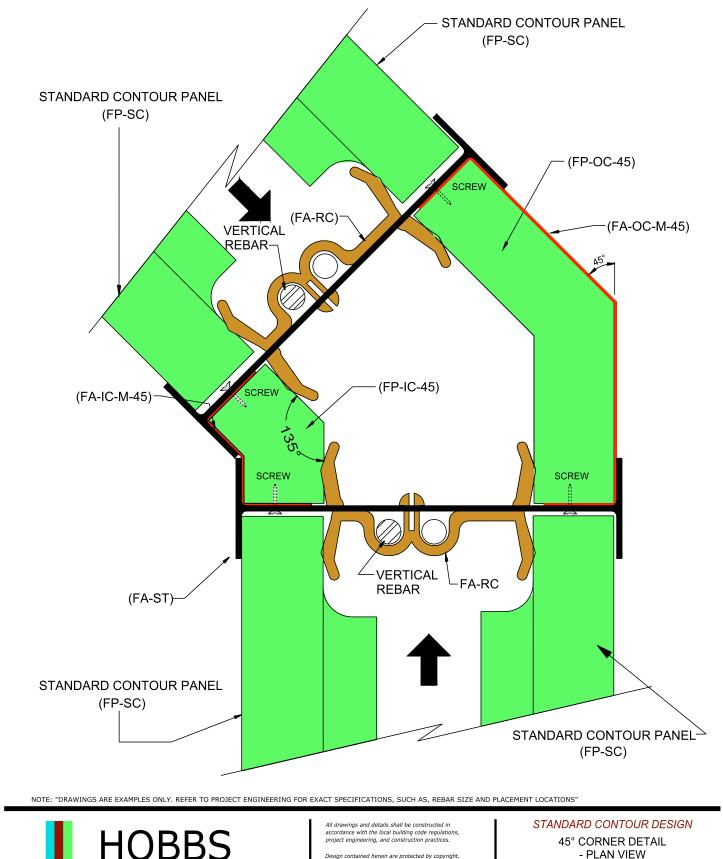

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Date: 05/08/2009	Drawn By: S.K.V.	Scale: N.T.S.
Revision #: 1	DWG #:	20.04
Revision Date: 12/11/2009	ST-10	JU.U1






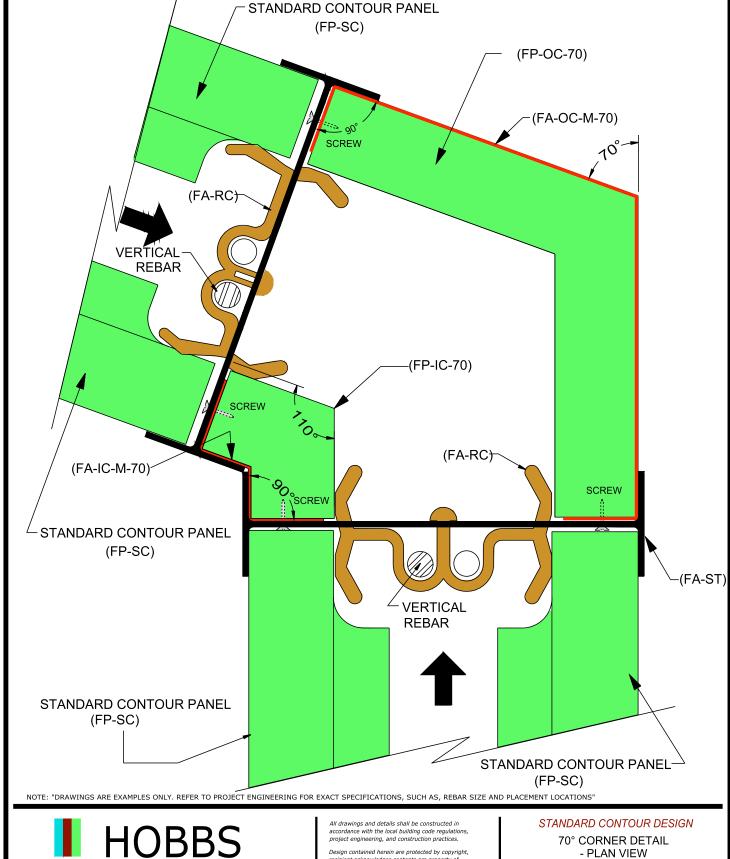

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Date: 05/08/2009	Drawn By: S.K.V.	Scale: N.T.S.
Revision #:	DWG #:	
Revision Date: 12/11/2009	ST-10	00.02



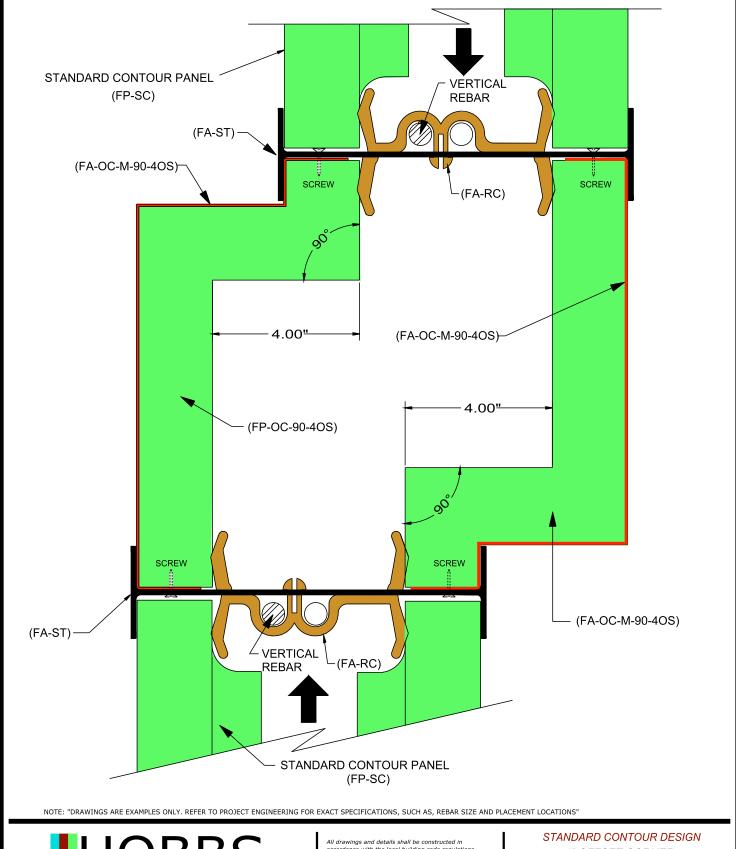

IHOBBS

Vertical ICF Wall System


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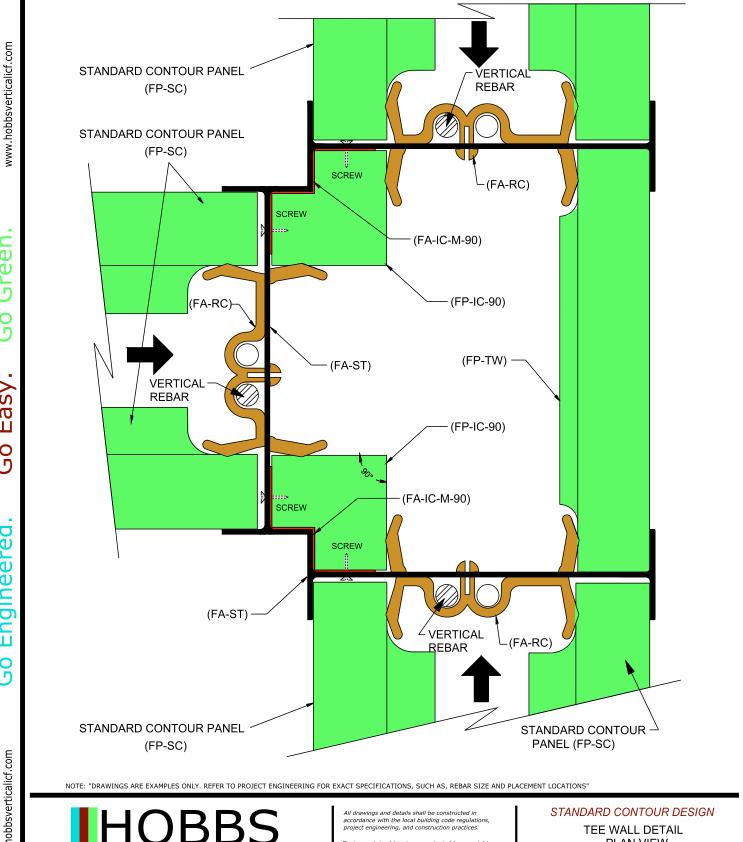
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4" OFFSET CORNER DETAIL - PLAN VIEW

Date: 05/08/2009	Drawn By: S.K.V.	Scale: N.T.S.	
Revision #:	DWG #:		
Revision Date: 12/11/2009	ST-	ST-100.03	







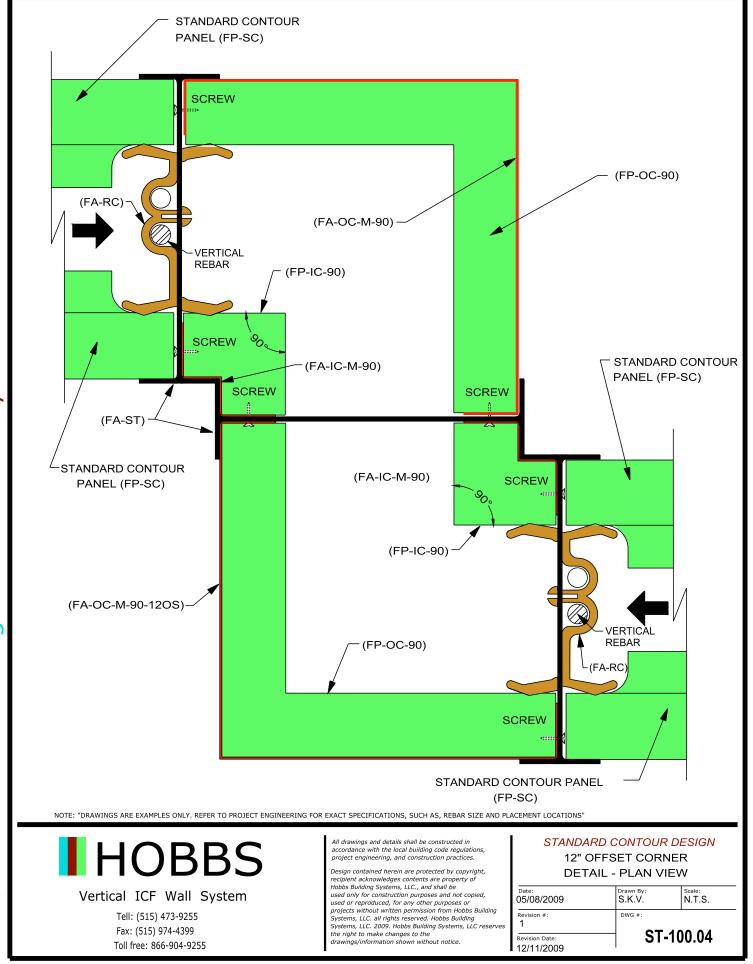

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Date: 05/08/2009	Drawn By: S.K.V.	Scale: N.T.S.	
Revision #:	DWG #:		
Revision Date: 12/11/2009	ST-	ST-100.05	




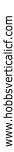

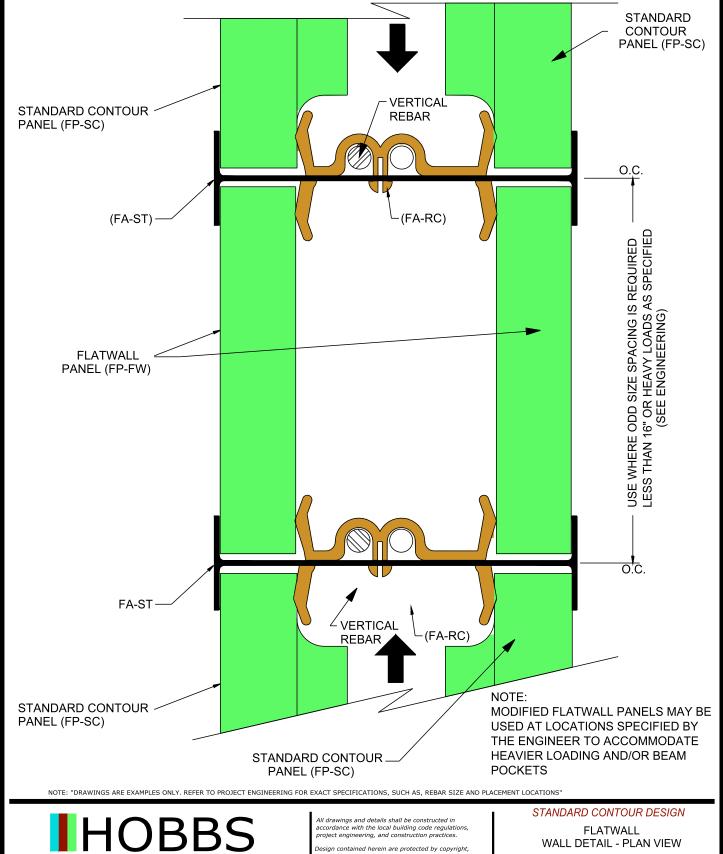

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Date: 05/08/2009	Drawn By: S.K.V.	Scale: N.T.S.
Revision #: 2	DWG #:	
Revision Date: 02/10/2010	ST-10	00.06



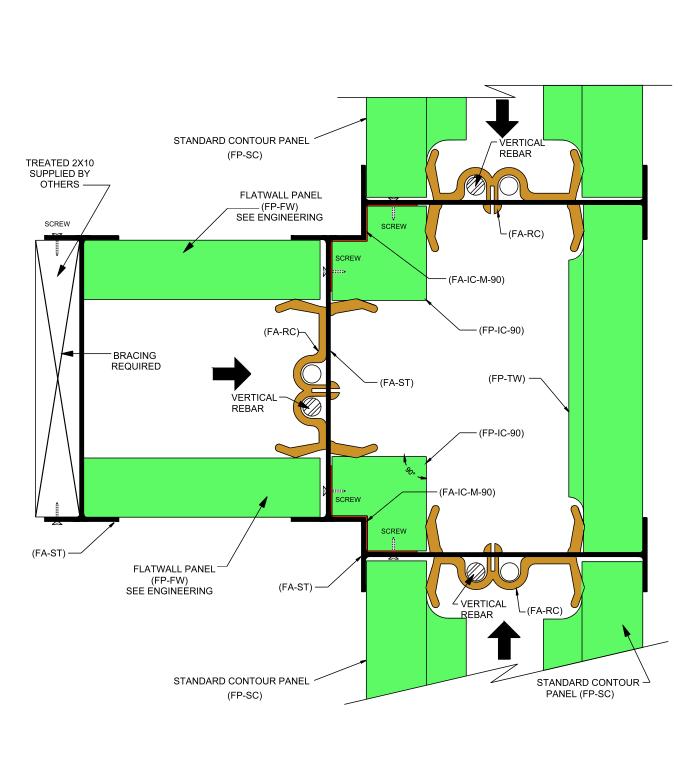

Vertical ICF Wall System

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STANDARD CONTOUR DESIGN


FULL HEIGHT INTERIOR PILASTER - PLAN VIEW

Date: Drawn By: Scale: N.T.S.

Revision #: Drawn By: S.K.V. N.T.S.

DWG #: ST-100.07

Revision Date: O2/19/2010

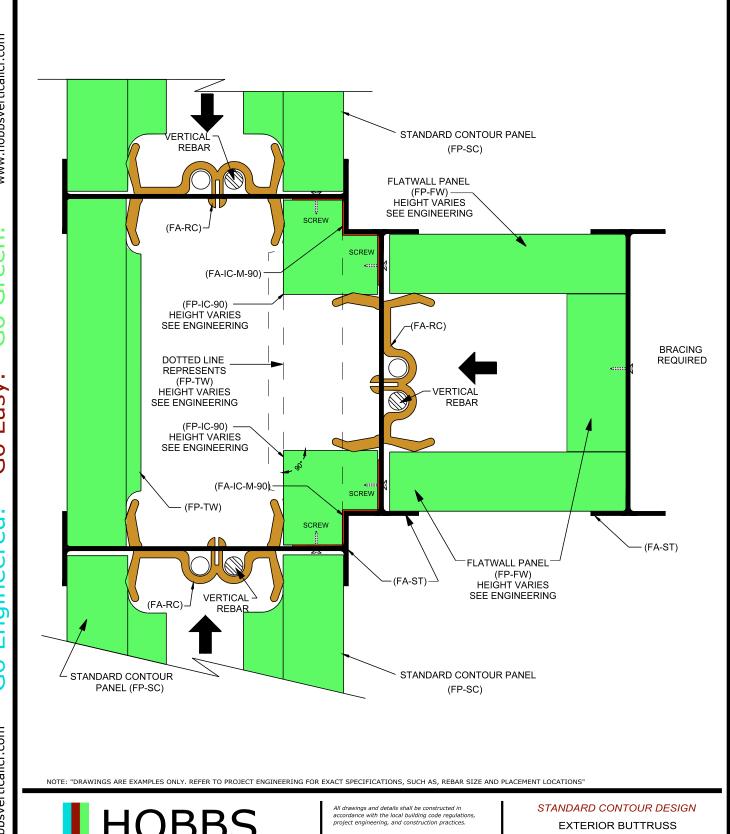



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Date: 05/08/2009	Drawn By: S.K.V.	Scale: N.T.S.	
Revision #:	DWG #:		
Revision Date: 02/19/2010	ST	ST-100.08	